


SEA BRIGHT BOROUGH HALL W-5867

FA: 14651797 1167 OCEAN AVE SEA BRIGHT, NJ 07760 **NEW SITE BUILD**

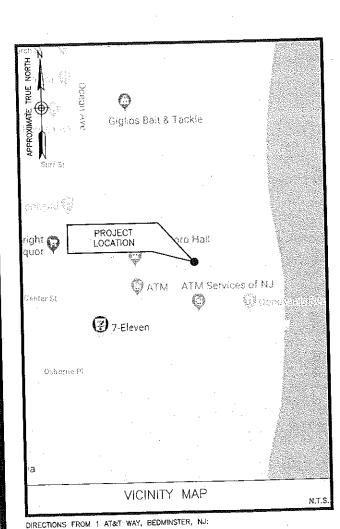

SITE COORDINATES: LATITUDE: 40"-21"-35.41" N LONGITUDE: 73"-58"-23.23" W DATUM: NAO 83

ELEVATION DATA

ANTENNA ELEVATION (TO C.L. OF ANTENNAS)

AT&T ALPHA/BETA SECTORS: 85'-0"± A.G.L.

AT&T GAMMA SECTOR: 55'-0"± A.G.L.

ELEVATION (TO TOP OF MONOPOLE)

ELEVATION = 110'± A.G.L.

ELEVATION (TO TOP OF DECORATIVE BALL)

ELEVATION = 112'-2" + A.G.L.

SITE INFORMATION

THE PROJECT CONSISTS OF: THE INSTALLATION OF (3) ANTENNAS & (12) QUADPLEXERS WITHIN AN THE INSTALLATION OF (3) ANTENNAS & (12) QUADPLEXERS WITHIN ANEXTENDED CONCEALMENT MONOPOLE. THE INSTALLATION OF (2) EQUIPMENT
CABINETS, (1) NATURAL GAS GENERATOR, (12) RRH'S, (12) QUADPLEXERS, (2)
DC12 SURGE ARRESTORS, (2) FIBER MANAGEMENT BOXES & POWER/TELOO
PANELS INSTALLED ON AN ELEVATED EQUIPMENT PLATFORM WITH A LOUVERED
SCREENWALL THE INSTALLATION OF (2) GPS ANTENNAS MOUNTED TO THE
LOUVERED SCREENWALL. THE INSTALLATION OF ASSOCIATED POWER, FIBER,
GROUND CONDUITS & NATURAL GAS PIPING FOR A COMPLETE INSTALLATION.

PROJECT DESCRIPTION

THIS DOCUMENT WAS DEVELOPED TO REFLECT A SPECIFIC SITE AND ITS SITE CONDITIONS AND IS NOT TO BE USED FOR ANOTHER SITE OR WHEN OTHER CONDITIONS PERTAIN. REUSE OF THIS DOCUMENT IS AT THE SOLE RISK OF

A.D.A. COMPLIANCE

FACILITY IS UNMANNED AND NOT FOR HUMAN HABITATION.

<u>SITE_NAME</u>: SEA BRIGHT BOROUGH HALL W-5867 SITE ADDRESS:

1167 OCEAN AVE SEA BRIGHT, NJ 07760 MONMOUTH COUNTY

TAX MAP DESIGNATION: BLOCK: 20 LOT: 7

ZONING DESIGNATION: B-1 (M)

TOWER OWNER: BOROUGH OF SEA BRIGHT 1099 OCEAN AVENUE SEA BRIGHT, NJ 07760

APPLICANT:
NEW CINGULAR WIRELESS AT&T
1 AT&T WAY
BEDMINSTER, NJ 07921

PROJECT INFORMATION

SITE ACQUISITION: AIROSMITH DEVELOPMENT PHONE: (201) 290-4580

PROJECT MANAGER:
WILLIAM STONE
AIROSMITH DEVELOPMENT
PHONE: (518) 210-0495

ENGINEER:
BRYAN HUFF
DEWBERRY ENGINEERS INC. PHONE: (973) 576-0147

CONTACT INFORMATION

SHEET NUMBER	DESCRIPTION					
T-1	TITLE SHEET					
1						
G-1	GENERAL NOTES					
C-1	COMPOUND PLAN					
C-2	SOUTHEAST ELEVATION & EQUIPMENT PLAN					
C-3	DETAILED EQUIPMENT ELEVATIONS					
C-4	CONSTRUCTION DETAILS I					
C-5	LOUVERED SCREENWALL DETAILS					
C-6	EQUIPMENT DETAILS					
C-7	EQUIPMENT MOUNTING DETAILS					
C-8	ANTENNA & RRH DETAILS & NOTES					
C-9	PROPOSED ANTENNA PLANS					
C-10	COLOR CODING, PLUMBING DIAGRAM & B.O.M.					
S-1	EQUIPMENT PLATFORM STRUCTURAL PLAN					
5-2	PLATFORM STRUCTURAL DETAILS I					
S-3	PLATFORM STRUCTURAL DETAILS II					
S-4	FENCE LAYOUT & CONNECTION DETAILS					
E-1	ELECTRICAL RISER DIAGRAM & ELECTRICAL NOTES					
E-2	GROUNDING PLAN & GROUNDING NOTES					
E-3	GROUNDING DETAILS					
P-1	GENERAL PLUMBING NOTES					
P-2	GAS RISER DIAGRAM & PLUMBING DETAILS					
P-3	NATURAL GAS GENERATOR DETAILS					
P-4	NATURAL GAS BOOSTER DETAILS					
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NEW JERSEY ONE CALL PHONE #: (800) 272-1000 WWW.NJ1-CALL.ORG



New Cingular Wireless PCS, LLC One AT&T Way Bedminster, NJ 07921



SEA BRIGHT BOROUGH HALL W-5867

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@ Dewberry

Dewberry Engineers Inc. 600 PARSIPPANY ROAD SUITE 301 PARSIPPANY, NJ 07054 PHONE: 973.739.9400 FAX: 973.739.9710 COA 24GA28047600

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PROJECT NUMBER:	50110598
JOB NUMBER:	50110611
SITE ADDRESS:	

1167 OCEAN AVE SEA BRIGHT, NJ 07760 MONMOUTH COUNTY

SHEET TITLE

TITLE SHEET

SHEET NUMBER

T — 1

GET ON I-287 S FROM AT&T WAY AND HEAD SOUTH TOWARD AT&T WAY, TURN SLIGHT RIGHT ONTO AT&T WAY AND MERGE ONTO US-202 S/US-206 S, USE THE RIGHT LANE TO TAKE INTERSTATE 287 S RAMP TO INTERSTATE 78, MERGE ONTO 1-287 S, KEEP LEFT TO CONTINUE ON N.1-440 N, TAKE THE GARDEN STATE PARKWAY S EXIT, MERGE ONTO GARDEN STATE PKWY, USE THE MIDDLE 2 LANES TO KEEP LEFT AT THE FORK AND STAY ON GARDEN STATE PKWY, KEEP RIGHT AT THE FORK TO STAY ON GARDEN STATE PKWY, TAKE EXIT 109 FOR COUNTY RD 520 TOWARD STAY ON GARDEN STATE PKWY, KEEP RIGHT AT THE FORK TO STAY ON GARDEN STATE PKWY, TAKE EXIT 109 FOR COUNTY RD 520 TOWARD STAY ON GARDEN STATE PKWY, KEEP RIGHT AT THE FORK TO STAY ON GARDEN STATE PKWY. TOWARD RED BANK/LINGROFT, CONTINUE ON COUNTY RD 520/NEWMAN SPRINGS RD, TAKE RUMSON RD TO WAYNE ST IN SEA BRIGHT, TURN LEFT ONTO COUNTY RD 520/NEWMAN SPRINGS RD, TURN LEFT ONTO NJ-35 N/BROAD ST, CONTINUE STRAIGHT ONTO BROAD ST, TURN RIGHT ONTO PINCKNEY RD, TURN RIGHT ONTO BRANCH AVE, TURN LEFT ONTO RUMSON RD, CONTINUE ONTO SHREWSBURY RIVER BRIDGE, TURN RIGHT ONTO OCEAN AVE, TURN LEFT ONTO E CENTER ST, E CENTER ST TURNS LEFT AND BECOMES WAYNE ST, DESTINATION WILL BE ON THE LEFT.

GENERAL CONSTRUCTION NOTES:

- . ALL WORK SHALL CONFORM TO ALL CURRENT APPLICABLE FEDERAL, STATE, AND LOCAL CODES, INCLUDING ANSI/EIA/TIA-222, AND COMPLY WITH AT&T SPECIFICATIONS.
- CONTRACTOR SHALL CONTACT "CALL BEFORE YOU DIG" (811) FOR IDENTIFICATION OF UNDERGROUND
 UTILITIES PRIOR TO START OF CONSTRUCTION.
- 3. CONTRACTOR IS RESPONSIBLE FOR COORDINATING ALL REQUIRED INSPECTIONS.
- 4. ALL DIMENSIONS TO, OF, AND ON EXISTING BUILDINGS, DRAINAGE STRUCTURES, AND SITE IMPROVEMENTS SHALL BE VERIFIED IN FIELD BY CONTRACTOR WITH ALL DISCREPANCIES REPORTED TO THE ENGINEER.
- 5. DO NOT CHANGE SIZE OR SPACING OF STRUCTURAL ELEMENTS.
- 5. DETAILS SHOWN ARE TYPICAL; SIMILAR DETAILS APPLY TO SIMILAR CONDITIONS UNLESS OTHERWISE
- THESE DRAWINGS DO NOT INCLUDE NECESSARY COMPONENTS FOR CONSTRUCTION SAFETY WHICH IS THE SOLE RESPONSIBILITY OF THE CONTRACTOR
- CONTRACTOR SHALL BRACE STRUCTURES UNTIL ALL STRUCTURAL ELEMENTS NEEDED FOR STABILITY ARE INSTALLED. THESE ELEMENTS ARE AS FOLLOWS: LATERAL BRACING, ANCHOR BOLTS, ETC.
- CONTRACTOR SHALL DETERMINE EXACT LOCATION OF EXISTING UTILITIES, GROUNDS DRAINS, DRAIN PIPES, ETC. BEFORE COMMENCING WORK.
- 10. INCORRECTLY FABRICATED, DAMAGED, OR OTHERWISE MISFITTING OR NONCONFORMING MATERIALS OR CONDITIONS SHALL BE REPORTED TO THE OWNER PRIOR TO REMEDIAL OR CORRECTIVE ACTION, ANY SUCH REMEDIAL ACTION SHALL REQUIRE WRITTEN APPROVAL BY THE OWNER'S REPRESENTATIVE PRIOR TO PROCEEDING.
- 11. EACH CONTRACTOR SHALL COOPERATE WITH THE OWNER'S REPRESENTATIVE, AND COORDINATE HIS WORK WITH THE WORK OF OTHERS.
- 12. CONTRACTOR SHALL REPAIR ANY DAMAGE CAUSED BY CONSTRUCTION OF THIS PROJECT TO MATCH EXISTING PRE-CONSTRUCTION CONDITIONS TO THE SATISFACTION OF THE AT&T CONSTRUCTION MANAGERS
- 13. WHERE EXISTING CONDITIONS DO NOT MATCH THOSE SHOWN IN THIS PLAN SET, CONTRACTOR WILL NOTIFY ENGINEER, AT&T PROJECT CONSTRUCTION MANAGER, AND LANDLORD IMMEDIATELY.
- CONTRACTOR SHALL ENSURE ALL SUBCONTRACTORS ARE PROVIDED WITH A CURRENT SET OF DRAWINGS AND SPECIFICATIONS FOR THIS PROJECT.
- 15. CONTRACTOR SHALL REMOVE ALL RUBBISH AND DEBRIS FROM THE SITE AT THE END OF EACH DAY.
- 16. CONTRACTOR SHALL COORDINATE WORK SCHEDULE WITH LANDLORD AND TAKE PRECAUTIONS TO MINIMIZE IMPACT AND DISRUPTION OF OTHER OCCUPANTS OF THE FACILITY.
- CONTRACTOR SHALL FURNISH AT&T WITH THREE AS—BUILT SETS OF DRAWINGS EACH UPON COMPLETION OF WORK.
- 18. ANTENNAS AND CABLES ARE TYPICALLY PROVIDED BY AT&T. PRIOR TO SUBMISSION OF BID, CONTRACTOR SHALL COORDINATE WITH AT&T PROJECT MANAGERS TO DETERMINE WHAT, IF ANY, ITEMS WILL BE PROVIDED BY AT&T. ALL ITEMS NOT PROVIDED BY AT&T SHALL BE PROVIDED AND INSTALLED BY THE CONTRACTOR. CONTRACTOR WILL INSTALL ALL ITEMS PROVIDED BY AT&T.
- 19. PRIOR TO SUBMISSION OF BID, CONTRACTOR WILL COORDINATE WITH AT&T PROJECT MANAGERS TO DETERMINE IF ANY PERMITS WILL BE OBTAINED BY AT&T. ALL REQUIRED PERMITS NOT OBTAINED BY AT&T MUST BE OBTAINED, AND PAID FOR, BY THE CONTRACTOR.
- 20. CONTRACTOR SHALL INSTALL ALL SITE SIGNAGE IN ACCORDANCE WITH AT&T SPECIFICATIONS AND REQUIREMENTS.
- CONTRACTOR SHALL SUBMIT ALL SHOP DRAWINGS TO ENGINEER FOR REVIEW AND APPROVAL PRIOR TO FABRICATION,
- 22. UNLESS OTHERWISE NOTED AT&T SHALL PROVIDE ALL REQUIRED RF MATERIAL FOR CONTRACTOR TO INSTALL, INCLUDING ANTENNAS, TMA'S, RRH'S, BIAS-T'S, COMBINERS, PDU, DC BLOCKS, SURGE ARRESTORS, OVP'S, GPS ANTENNA, GPS SURGE ARRESTOR, COAXIAL CABLE.
- 23. PRIOR TO SUBMISSION OF BID, CONTRACTOR SHALL VERIFY ALL EQUIPMENT TO BE PROVIDED BY AT&T FOR INSTALLATION BY CONTRACTOR.
- 24. ALL EQUIPMENT SHALL BE INSTALLED ACCORDING TO MANUFACTURER'S SPECIFICATIONS AND LOCATED ACCORDING TO AT&T SPECIFICATIONS, AND AS SHOWN IN THESE PLANS.
- 25. THE CONTRACTOR SHALL SUPERVISE AND DIRECT THE PROJECT DESCRIBED HEREIN, THE CONTRACTOR SHALL BE SOLELY RESPONSIBLE FOR ALL THE CONSTRUCTION MEANS, METHODS, TECHNIQUES, SEQUENCES AND PROCEDURES AND FOR COORDINATING ALL PORTIONS OF THE WORK UNDER THE CONTRACT.
- 26. CONTRACTOR SHALL NOTIFY DEWBERRY 48 HOURS IN ADVANCE OF POURING CONCRETE, OR BACKFILLING TRENCHES, SEALING ROOF AND WALL PENETRATIONS & POST DOWNS, FINISHING NEW WALLS OR FINAL ELECTRICAL CONNECTIONS FOR ENGINEER REVIEW.
- 27. CONTRACTOR SHALL BE RESPONSIBLE FOR SITE SAFETY INCLUDING COMPLIANCE WITH ALL APPLICABLE OSHA STANDARDS AND RECOMMENDATIONS AND SHALL PROVIDE ALL NECESSARY SAFETY DEVICES INCLUDING PPE AND PPM AND CONSTRUCTION DEVICES SUCH AS WELDING AND FIRE PREVENTION, TEMPORARY SHORING, SCAFFOLDING, TRENCH BOXES/SLOPING, BARRIERS, ETC.
- 28. CONTRACTOR SHALL FOLLOW THE APPROVED WORK PLAN FOR THE SITE AND HAVE WORKERS THAT ARE OSHA APPROVED FOR ANY WORK WHICH INVOLVES THE SOIL OR GROUNDWATER.
- 29. ALL WORK TO BE COMPLETED BY CONTRACTOR UNLESS NOTED OTHERWISE.
- 30. SEAL PENETRATIONS THROUGH FIRE RATED AREAS WITH UL LISTED D FIRE CODE APPROVED MATERIALS.
- REPAIR ANY DAMAGE DURING CONSTRUCTION TO MATCH EXISTING PRE-CONSTRUCTION CONDITIONS TO THE SATISFACTION OF THE CONSTRUCTION MANAGER AND LANDLORD.
- 32. ALL CABLE/CONDUIT ENTRY/EXIT PORTS SHALL BE WEATHERPROOFED DURING INSTALLATION USING A SILICONE SEALANT
- 33. SHIM NEW SILLS, AS NECESSARY, TO LEVEL AND PLUMB WALL.
- 34. ALL DISRUPTIVE WORK AND WORK WITHIN TENANTS SPACES TO BE COORDINATED WITH BUILDING REPRESENTATIVE

CONCRETE AND REINFORCING STEEL NOTES:

- DESIGN AND CONSTRUCTION OF ALL CONCRETE ELEMENTS SHALL CONFORM TO THE LATEST EDITIONS
 OF ALL APPLICABLE CODES INCLUDING: ACI 301 "SPECIFICATIONS FOR STRUCTURAL CONCRETE FOR
 BUILDINGS", AND ACI 318 "BUILDING CODE REQUIREMENTS FOR REINFORCED CONCRETE".
- 2. MIX DESIGN SHALL BE APPROVED BY OWNER'S REPRESENTATIVE AND SUBMITTED TO ENGINEER PRIOR TO PLACING CONCRETE.
- CONCRETE SHALL BE NORMAL WEIGHT, 6 % AIR ENTRAINED (+/- 1.5%) WITH A MAXIMUM 4" SLUMP AND HAVE A MINIMUM 28-DAY COMPRESSIVE STRENGTH OF 4000 PSI UNLESS OTHERWISE NOTED.
- 4. THE FOLLOWING MATERIALS SHALL BE USED:
 PORTLAND CEMENT: ASTM C-150, TYPE 1 OR 2
 REINFORCEMENT: ASTM A-185, PLAIN STEEL WELDED WIRE FABRIC
 REINFORCEMENT BARS: ASTM A615, GRADE 60, DEFORMED
 NORMAL WEIGHT AGGREGATE: ASTM C-33
 WATTER: DRINKABLE
 ADMIXTURES: NON-CHLORIDE CONTAINING
- MINIMUM CONCRETE COVER FOR REINFORCING STEEL SHALL BE AS FOLLOWS (UNLESS OTHERWISE NOTED):
 A. CONCRETE CAST AGAINST EARTH: 3"
- 6. A 3/4" CHAMFER SHALL BE PROVIDED AT ALL EXPOSED EDGES OF CONCRETE IN ACCORDANCE WITH ACI 301 SECTION 4.2.4, UNLESS NOTED OTHERWISE.
- 7. INSTALLATION OF CONCRETE EXPANSION/WEDGE ANCHOR SHALL BE PER MANUFACTURER'S WRITTEN RECOMMENDED PROCEDURE. THE ANCHOR BOLT, DOWEL, OR ROD SHALL CONFORM TO MANUFACTURER'S RECOMMENDATION FOR EMBEDMENT DEPTH OR AS SHOWN ON THE DRAWINGS. NO REBAR SHALL BE CUT WITHOUT PRIOR ENGINEERING APPROVAL WHEN DEILLING HOLES IN CONCRETE.
- 8. ADMIXTURES SHALL CONFORM TO THE APPROPRIATE ASTM STANDARD AS REFERENCED IN ACI 301.
- 9. DO NOT WELD OR TACK WELD REINFORCING STEEL.
- ALL DOWELS, ANCHOR BOLTS, EMBEDDED STEEL, ELECTRICAL CONDUITS, PIPE SLEEVES, GROUNDS AND ALL OTHER EMBEDDED ITEMS AND FORMED DETAILS SHALL BE IN PLACE BEFORE START OF CONCRETE PLACEMENT.
- 11. REINFORCEMENT SHALL BE COLD BENT WHENEVER BENDING IS REQUIRED.
- 12. DO NOT PLACE CONCRETE IN WATER, ICE, OR ON FROZEN GROUND.
- DO NOT ALLOW REINFORCEMENT, CONCRETE OR SUBBASE TO FREEZE DURING CONCRETE CURING AND SETTING PERIOD, OR FOR A MINIMUM OF 3 DAYS AFTER PLACEMENT.
- 14. FOR COLD—WEATHER AND HOT—WEATHER CONCRETE PLACEMENT, CONFORM TO APPLICABLE ACL CODES AND RECOMMENDATIONS. IN EITHER CASE, MATERIALS CONTAINING CHLORIDE, CALCIUM, SALTS, ETC. SHALL NOT BE USED. PROTECT FRESH CONCRETE FROM WEATHER FOR 7 DAYS, MINIMUM.
- CONCRETE SHALL BE RUBBED TO A ROUGH GROUT FINISH. PADS SHALL BE SEALED BY STEEL TROWEL.
- 16. UNLESS OTHERWISE NOTED:
 - A. ALL REINFORCING STEEL SHALL BE DEFORMED BARS CONFORMING TO ASTM A615, GRADE 60.
 - B. WELDED WIRE FABRIC SHALL CONFORM TO ASTM A185.
- 17. SPLICING OF REINFORCEMENT IS PERMITTED ONLY AT LOCATIONS SHOWN IN THE CONTRACT DRAWINGS OR AS ACCEPTED BY THE ENGINEER. UNLESS OTHERWISE SHOWN OR NOTED REINFORCING STEEL SHALL BE SPLICED TO DEVELOP ITS FULL TENSILE CAPACITY (CLASS A) IN ACCORDANCE WITH ACI 318.
- 18. REINFORCING BAR DEVELOPMENT LENGTHS, AS COMPUTED IN ACCORDANCE WITH ACI 318, FORM THE BASIS FOR BAR EMBEDMENT LENGTHS AND BAR SPLICED LENGTHS SHOWN IN THE DRAWINGS. APPLY APPROPRIATE MODIFICATION FACTORS FOR TOP STEEL, BAR SPACING, COVER AND THE LIKE.
- DETAILING OF REINFORCING STEEL SHALL CONFORM TO "ACI MANUAL OF STANDARD PRACTICE FOR DETAILING REINFORCED CONCRETE STRUCTURES" (ACI 315).
- 20. ALL SLAB CONSTRUCTION SHALL BE CAST MONOLITHICALLY WITHOUT HORIZONTAL CONSTRUCTION JOINTS, UNLESS SHOWN IN THE CONTRACT DRAWINGS.
- 21. LOCATION OF ALL CONSTRUCTION JOINTS ARE SUBJECT TO THE REQUIREMENTS OF THE CONTRACT. DOCUMENTS, CONFORMANCE WITH ACI 318, AND ACCEPTANCE OF THE ENGINEER. DRAWINGS SHOWING LOCATION OF DETAILS OF THE PROPOSED CONSTRUCTION JOINTS SHALL BE SUBMITTED WITH REINFORCING STEEL PLACEMENT DRAWINGS
- 22. SPLICES OF WWF, AT ALL SPLICED EDGES, SHALL BE SUCH THAT THE OVERLAP MEASURED BETWEEN OUTERMOST CROSS WIRES OF EACH FABRIC SHEET IS NOT LESS THAN THE SPACING OF THE CROSS WIRE PLUS 2 INCHES, NOR LESS THAN 8".
- 23. BAR SUPPORTS SHALL BE ALL-GALVANIZED METAL WITH PLASTIC TIPS.
- 24. ALL REINFORCEMENT SHALL BE SECURELY TIED IN PLACE TO PREVENT DISPLACEMENT BY CONSTRUCTION TRAFFIC OR CONCRETE. TIE WIRE SHALL BE 16 GAUGE CONFORMING TO ASTM A82

STRUCTURAL NOTES:

- 1. AS REQUIRED UNDER THE STRUCTURAL STANDARD FOR ANTENNA SUPPORTING STRUCTURES AND ANTENNA, TIA/EIA-222-H, AT&T SHALL PROVIDE A STRUCTURAL ANALYSIS OF THE TOWER PREPARED BY A LICENSED STRUCTURAL ENGINEER CERTIFYING THAT THE EXISTING TOWER AND ANY REQUIRED IMPROVEMENTS AND REINFORCEMENTS HAVE SUFFICIENT CAPACITY TO SUPPORT ALL EXISTING AND PROPOSED ANTENNAS, SUPPORTS AND APPURTENANCES AND COMPLIES WITH THE CURRENT STATE BUILDING CODE AND EIA/TIA CRITERIA. THE CONTRACTOR IS RESPONSIBLE TO CONFIRM THAT ANY IMPROVEMENTS AND REINFORCEMENTS REQUIRED BY THE STRUCTURAL ANALYSIS CERTIFICATION ARE PROPERLY INSTALLED PRIOR TO THE ADDITION OF ANTENNAS, SUPPORTS AND APPURTENANCES PROPOSED ON THESE DRAWINGS OR OTHERWISE NOTED IN THE STRUCTURAL ANALYSIS.
- 2. FOR STRUCTURAL MODIFICATIONS REQUIRING FIELD WELDING; THE CONTRACTOR IS RESPONSIBLE FOR OBTAINING ALL REQUIRED PERMITS AND IMPLEMENTING ALL INDUSTRY STANDARDS FOR PROTECTION OF ALL EXISTING PROPERTY AND PERSONNEL FOR DAMAGE OR HARM, ALL PROPERTY DAMAGED DURING CONSTRUCTION OF THIS PROJECT SHALL BE REPLACED OR REPAIRED TO THE SATISFACTION OF THE OWNER.

GROUNDING NOTES:

- 1. GROUNDING SHALL COMPLY WITH NEC ART, 250.
- GROUND CONDUCTORS SHALL BE #6 COPPER STRANDED WIRE WITH GREEN COLOR INSULATION FOR INDOOR USE.
- 3. ALL GROUND CONNECTIONS TO BE BURNDY HYGROUND COMPRESSION TYPE CONNECTORS OR CADWELD EXOTHERMIC WELD DO NOT ALLOW BARE COPPER WIRE TO BE IN CONTACT WITH GALVANIZED STEEL.
- 4. ROUTE GROUNDING CONNECTORS ALONG THE SHORTEST AND STRAIGHTEST PATH POSSIBLE, EXCEPT AS OTHERWISE INDICATED. GROUNDING LEADS SHOULD NOT BE BENT AT RIGHT ANGLE. ALWAYS MAKE 12" RADIUS BENDS. #6 WIRE CAN BE BENT AT 6" RADIUS WHEN NECESSARY.
- CONNECTIONS TO GROUND BAR SHALL BE MADE WITH TWO HOLE COMPRESSION TYPE COPPER LUGS. APPLY OXIDE INHIBITING COMPOUND TO ALL LOCATIONS.
- TEST COMPLETED GROUND SYSTEM AND RECORD RESISTANCE VALUES FOR PROJECT CLOSE—OUT DOCUMENTATION. GROUND RESISTANCE SHALL NOT EXCEED 5 OHMS.
- 7. GROUND CONDUCTORS BETWEEN MGB AND WATERMAIN SHALL BE #2/0. BONDING JUMPERS FROM METALLIC SURFACES SHALL BE #2 MINIMUM. ALL GROUND CONDUCTORS AND BONDING JUMPERS SHALL BE SOFT DRAWN ANNEALED, TINNED, BARE STRANDED COPPER WIRE. COAXIAL CABLES SHALL BE GROUNDED AT A MINIMUM OF TWO LOCATIONS USING AT&T PROVIDED GROUNDING KITS. EXACT LOCATIONS SHALL BE FINALIZED IN THE FIELD BY THE CONSTRUCTION MANAGER.
- 8. ALL GROUNDING TO BE INSTALLED PER THE LATEST VERSION OF THE AT&T SPECIFICATION ATT—TP—76416 GROUNDING AND BONDING REQUIREMENTS FOR NETWORK FACILITIES.

FOUNDATION NOTES:

FOUNDATION DESIGN IS BASED ON THE GEOTECHNICAL TEST BORINGS PERFORMED BY CRAIG TEST BORING, DATED 06/24/2016.

1. DEEP FOUNDATION TYPE:

TIMBER PILE (ASTM D2

SOUTHERN YELLOW PINE NO. 2 OR APPROVED EQUAL 12" BUTT

2. PILE CAPACITY:

ULTIMATE COMPRESSIVE CAPACITY: 20 TONS ALLOWABLE COMPRESSIVE CAPACITY: 10 TONS LATERAL LOAD — FREE HEAD CONDITION: 1.5 TONS

3. INSTALLATION CRITERIA: FINISHED GRADE: EL. 0 (A.G.L.)

ESTIMATED TIP ELEVATION: -15
MINIMUM TIP ELEVATION: -10

4. PRIOR TO MOBILIZING PILE DRIVING EQUIPMENT, SUBMIT TO THE ENGINEER A WAVE EQUATION ANALYSIS DEMONSTRATING THE ADEQUACY OF THE PROPOSED DRIVING SYSTEM TO INSTALL THE PILES TO THE REQUIRED DEPTHS AND TO PENETRATION RATES NOT LESS THAN 3 BLOWS PER INCH AND NOT GREATER THAN 10 BLOWS PER INCH, WITHOUT OVERSTRESSING THE PILE.



New Cingular Wireless PCS, LLC One AT&T Way Bedminster, NJ 07921




SEA BRIGHT BOROUGH HALL W-5867

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Dewberry

Dewberry Engineers Inc.

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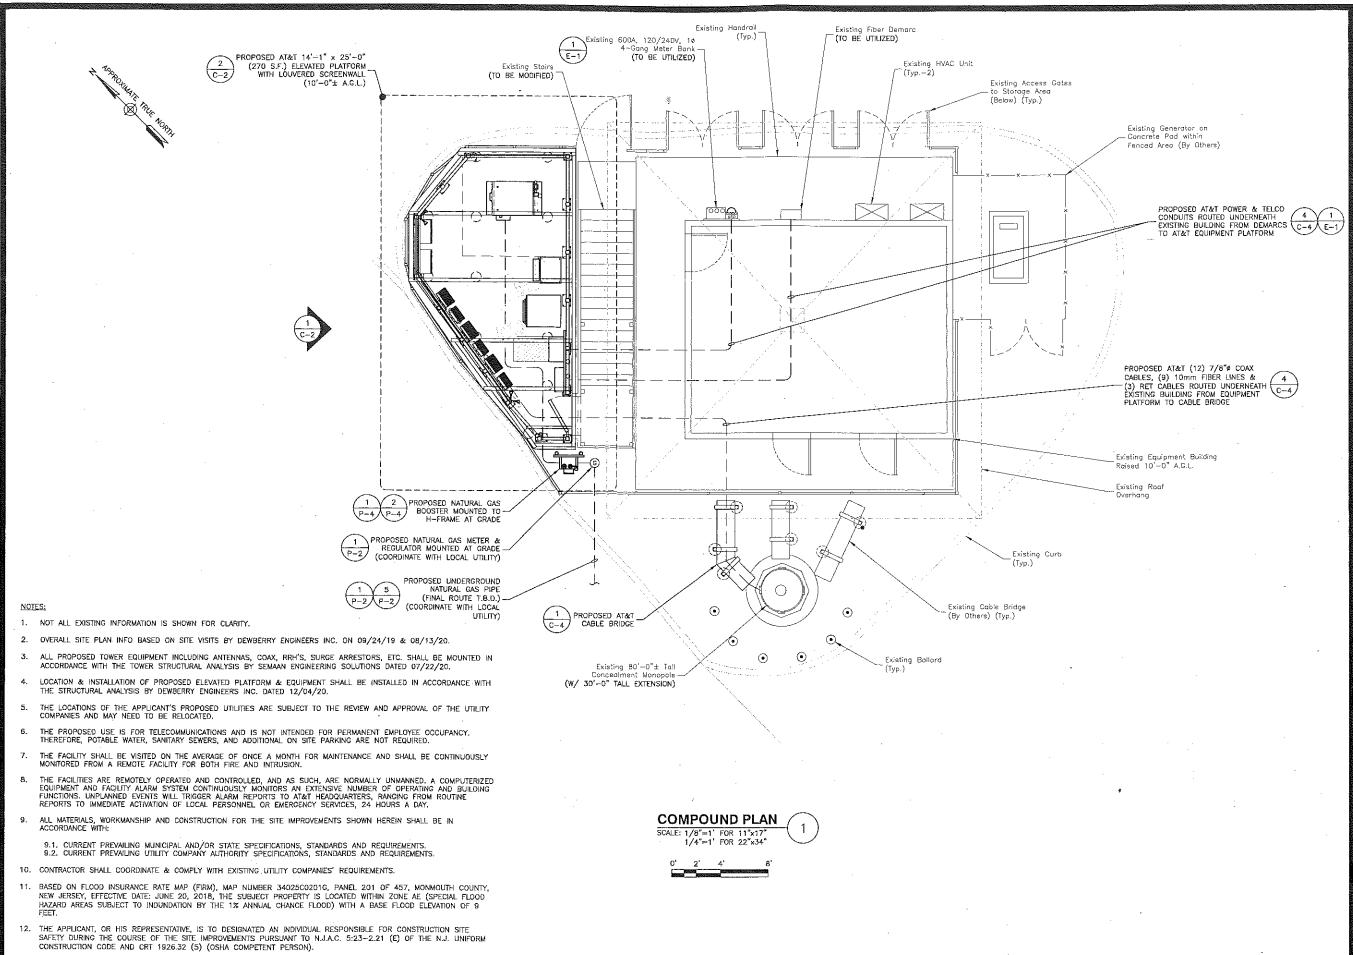
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SHEET TITLE

GENERAL NOTES

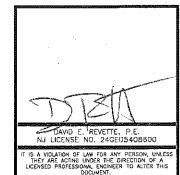SHEET NUMBER

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13. CONTRACTOR TO BE RESPONSIBLE FOR TRAFFIC CONTROL MEASURES AND SIGNAGE DURING CONSTRUCTION. COORDINATE WITH AT&T & OWNER.


14. CONTRACTOR TO VERIFY ALL UNDERGROUND UTILITIES PRIOR TO COMMENCING ANY SITE WORK ACTIVITIES.



New Cingular Wireless PCS, LLC One AT&T Way Bedminster, NJ 07921



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DRAWN BY: FG

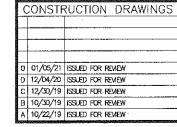REVIEWED BY: BSH

CHECKED BY: DER

PROJECT NUMBER: 50110598

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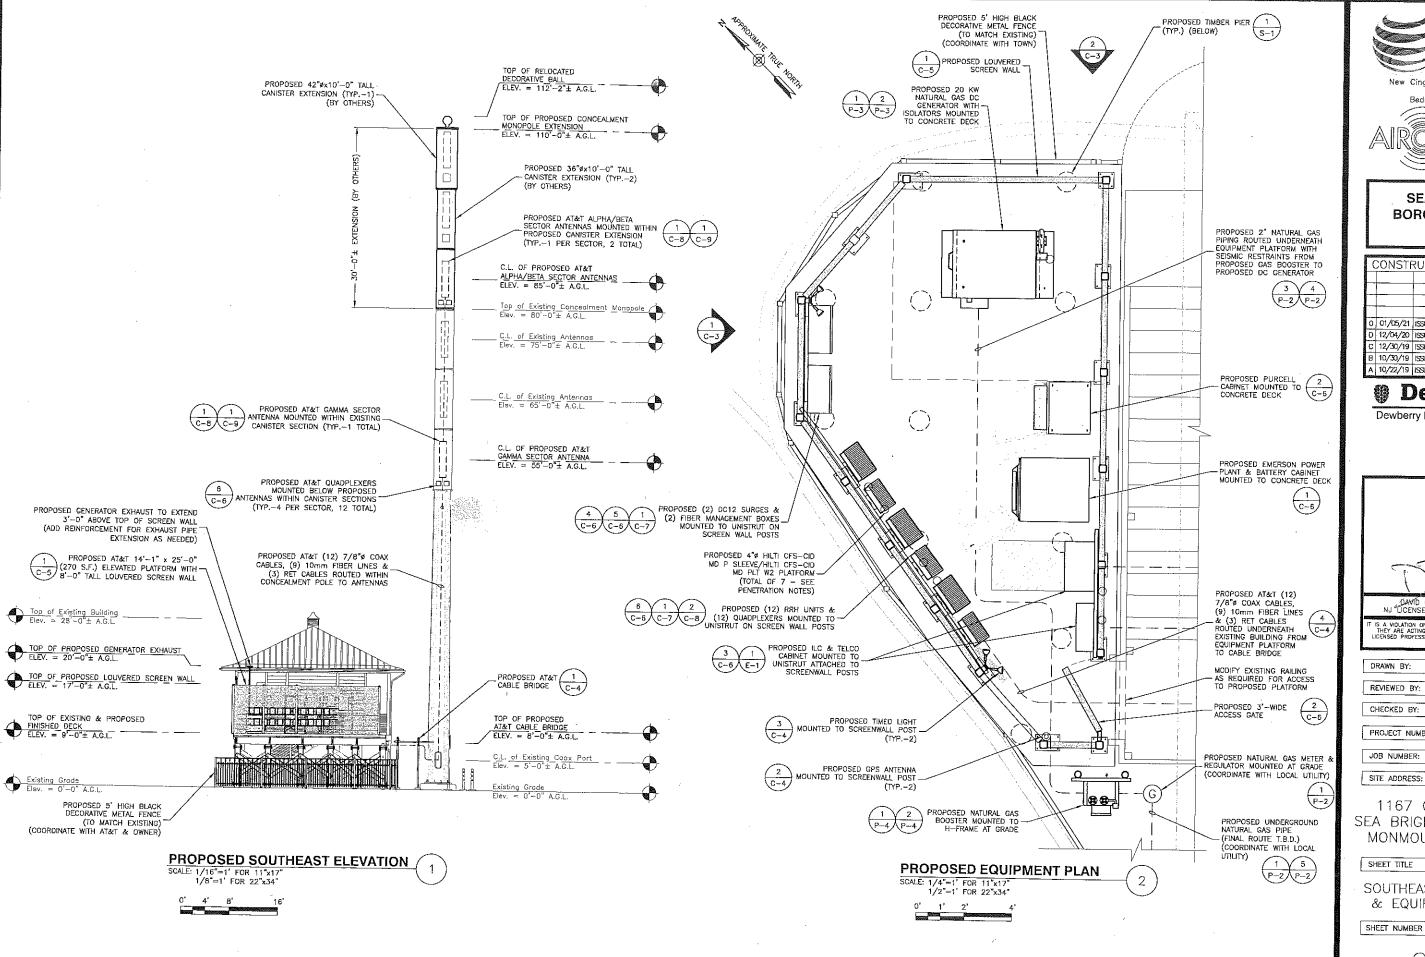
1167 OCEAN AVE SEA BRIGHT, NJ 07760 MONMOUTH COUNTY

SHEET TITLE

COMPOUND PLAN

SHEET NUMBER

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SEA BRIGHT BOROUGH HALL W-5867

	ISSUED FOR REVIEW
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B 10/30/19	ISSUED FOR REMEW
A 10/22/19	ISSUED FOR REVIEW

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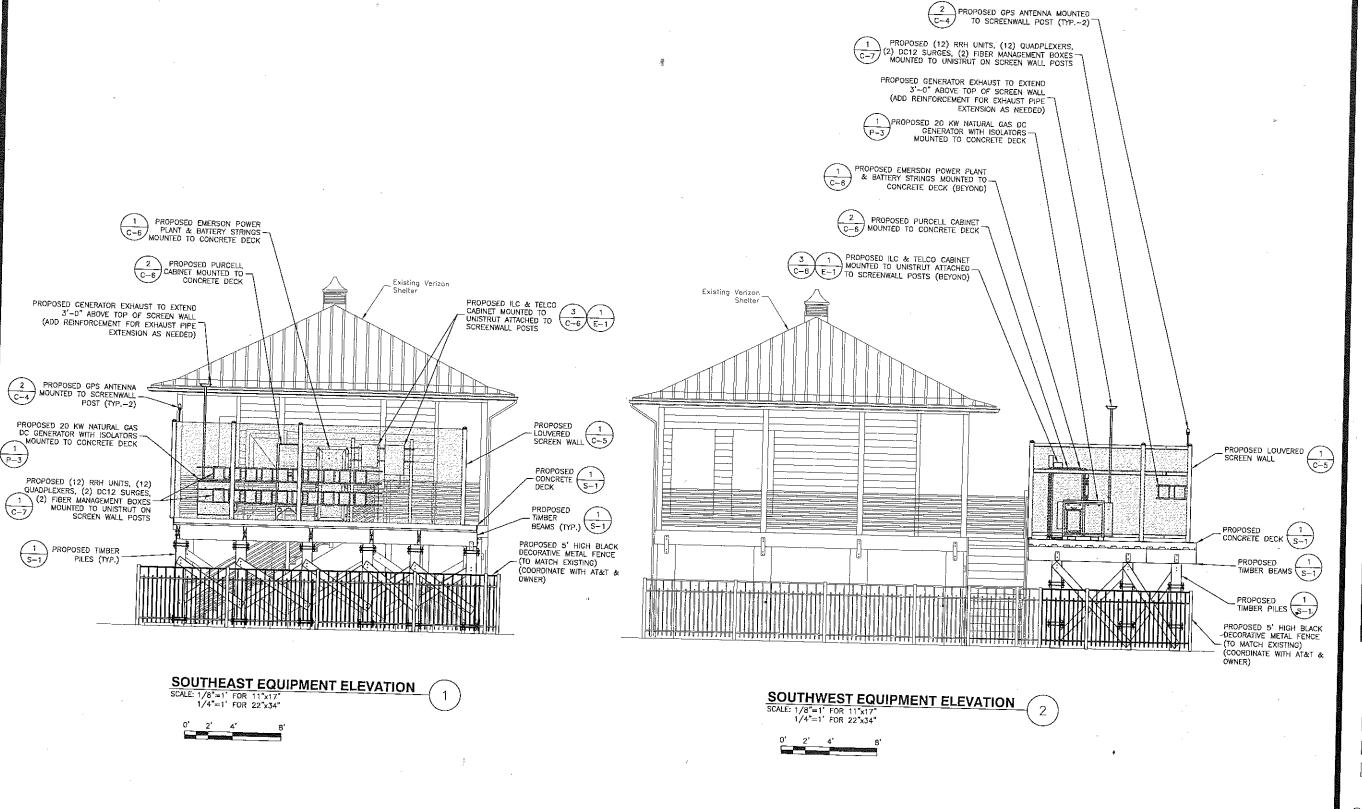


DRAWN BY: FG REVIEWED BY BSH CHECKED BY: DER PROJECT NUMBER: 50110598 JOB NUMBER: 50110611

1167 OCEAN AVE SEA BRIGHT, NJ 07760 MONMOUTH COUNTY

SHEET TITLE

SOUTHEAST ELEVATION & EQUIPMENT PLAN





New Cingular Wireless PCS, LLC One AT&T Way Bedminster, NJ 07921



SEA BRIGHT BOROUGH HALL W-5867

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Dewberry

A 10/22/19 ISSUED FOR REVIEW

Dewberry Engineers Inc. 600 PARSIPPANY ROAD SUITE 301 PARSIPPANY, NJ 07054 PHONE: 973.739.9400 FAX: 973.739.9710 COA 24GA28047600



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PROJECT NUMBER:	50110598
JOB NUMBER:	50110611
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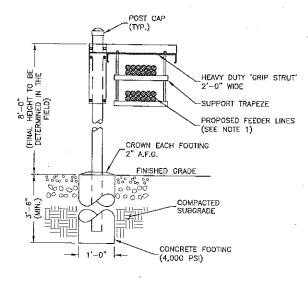
1167 OCEAN AVE SEA BRIGHT, NJ 07760 MONMOUTH COUNTY

SHEET TITLE

DETAILED EQUIPMENT ELEVATIONS

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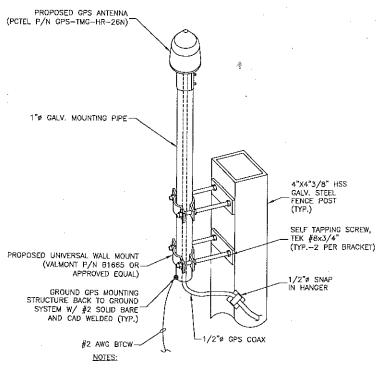
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CONNECT TO TIMBER JOIST WITH #10 X 3-1/2" LONG GALV, WOOD SCREWS (TYP.-2 PER STRUT)


- CABLE BRIDGE SHALL BE SITE PRO 1 24" GRIP-SPAN ICE BRIDGE KIT WITH Z-BRACKET TRAPEZE P/N: IB24D-216Z FOR UP TO 14 LINES & P/N IB24D-216Z2 FOR 15-28 LINES OR APPROVED EQUAL.
- 2. ALL COMPONENTS SHALL BE INSTALLED ACCORDING TO MANUFACTURER'S SPECIFICATIONS.
- CONTRACTOR SHALL DETERMINE REQUIRED QUANTITY OF ALL CABLE BRIDGE COMPONENTS.
- SNAP-IN HANGERS, SPLICE KITS, HINGE KITS, EXTENSION KITS, STIFFENERS, AND OTHER MISCELLANEOUS HARDWARE SHALL BE PROVIDED BY THE CONTRACTOR AS REQUIRED.
- 5. CABLE BRIDGE SHALL BE ROUTED TO ACCOMMODATE THE MINIMUM BENDING RADIUS OF
- CABLE BRIDGE COMPONENTS SHOWN ARE SCHEMATIC, CONSULT MANUFACTURER FOR EXACT AND CURRENT SPECIFICATIONS.





- 1. INSTALL PER MANUFACTURER'S RECOMMENDATIONS.
- MAINTAIN 10' HORIZONTAL SEPARATION BETWEEN PROPOSED GPS ANTENNAS.



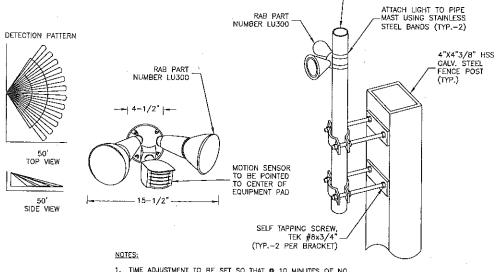

PROPOSED 2"ø PIPE MOUNT


- TIME ADJUSTMENT TO BE SET SO THAT @ 10 MINUTES OF NO MOVEMENT, FLOODLIGHT SHALL TURN OFF.
- 2. LIGHT TO BE MANUFACTURED BY RAB (OR APPROVED EQUAL).
- 3. PROVIDE EXTERIOR ELECTRICAL BOX AND MOUNTING HARDWARE AS

TIMED LIGHT DETAIL SCALE: N.T.S.

PROPOSED STRUT CABLE SUPPORT (TYP.) (UNISTRUT P1000 OR EQUAL) (10'-0" O.C. MAX FOR CONDUITS) (4'-0" O.C. MAX FOR COAX/FIBER) CONDUIT, PIPING, COAX, FIBER MOUNTED WITH APPROPRIATE STRUT HANGERS

CONDUIT ROUTING NOTES:

- COORDINATE FINAL CONDUIT ROUTING WITH AT&T CM & OWNER PRIOR TO CONSTRUCTION.
- 2. PROVIDE PIPE MOUNTING HARDWARE FOR PIPE CONNECTIONS TO STRUT.
- 3. GROUND STEEL CONDUIT
- 4. DO NOT BLOCK EXISTING VALVES, SPRINKLERS OR EQUIPMENT ACCESS LOCATIONS.
- 5. DETAIL IS SCHEMATIC. NUMBER & ORIENTATION VARIES.
- 6. CONTRACTOR TO IDENTIFY ALL CONDUIT PENETRATIONS. TURNS, PULL BOXES, EXPANSION JOINTS & VERIFY ROUTE W/CM & LANDLORD PRIOR TO CONSTRUCTION.

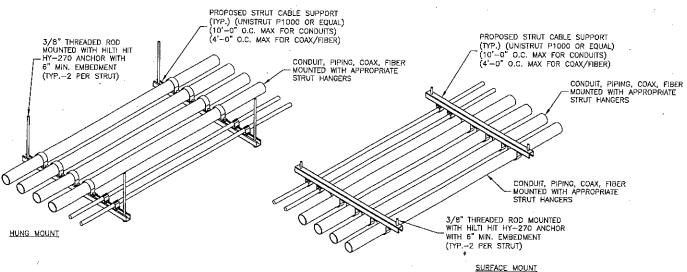

CONDUIT ROUTING NOTES:

- 1. COORDINATE FINAL CONDUIT ROUTING WITH AT&T CM & OWNER PRIOR TO CONSTRUCTION.
- 2. PROVIDE PIPE MOUNTING HARDWARE FOR PIPE CONNECTIONS TO STRUT.
- 3. GROUND STEEL CONDUIT.
- 4. DO NOT BLOCK EXISTING VALVES, SPRINKLERS OR EQUIPMENT ACCESS LOCATIONS.
- 5. DETAIL IS SCHEMATIC. NUMBER & ORIENTATION VARIES,
- CONTRACTOR TO IDENTIFY ALL CONDUIT PENETRATIONS, TURNS, PULL BOXES, EXPANSION JOINTS & VERIFY ROUTE W/CM & LANDLORD PRIOR TO CONSTRUCTION.

CONDUIT SUPPORT TO CONCRETE DECK SCALE: N.T.S.



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SEA BRIGHT BOROUGH HALL W-5867

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Dewberry

Dewberry Engineers Inc.

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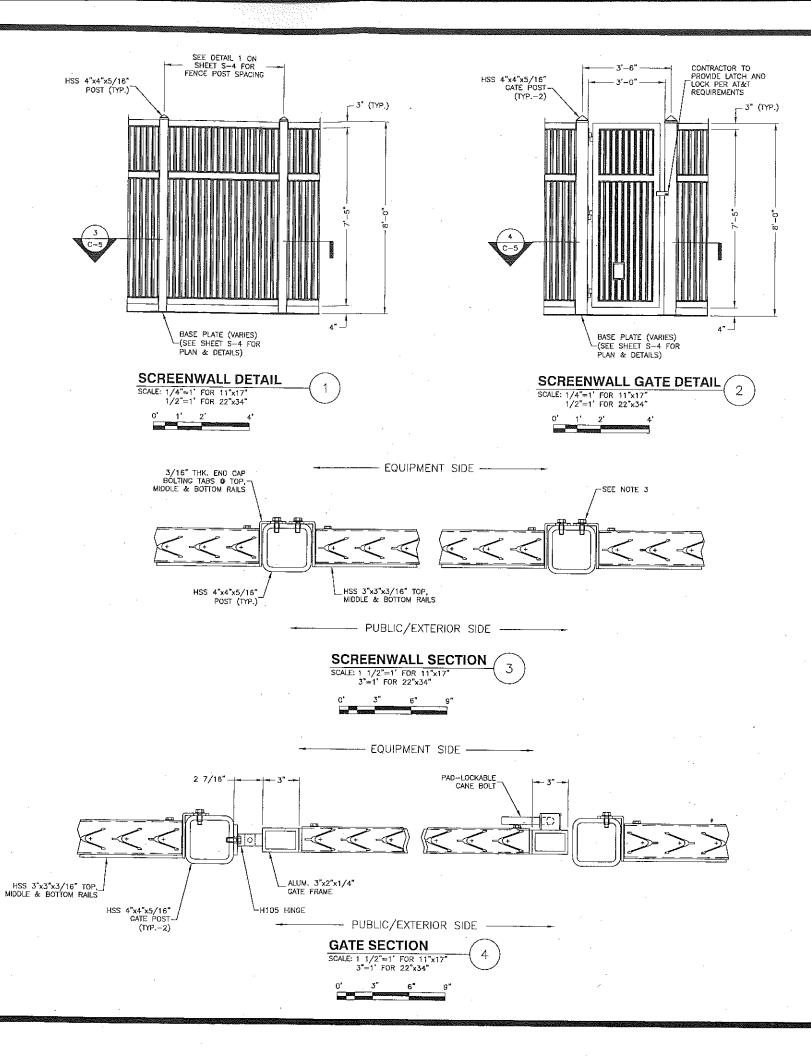
SHEET TITLE

CONSTRUCTION DETAILS I

GATE	SPECIFICATIONS
MANUFACTURER:	AMETCO
MODEL:	VENETIAN 100
COLOR:	COORDINATE WITH AT&T & OWNER
HEIGHT:	8'-0"
% OPENING:	18.93%

NOTES:

- PROPOSED ACCESS GATE TO HAVE AT&T APPROVED LOCK SYSTEM.
- POST TO BE HOT DIP GALVANIZED WITH POWDER POLYESTER PAINT COAT, COORDINATE COLOR WITH AT&T & OWNER.
- 3. ALL BOLTED CONNECTIONS SHALL UTILIZE TAMPER PROOF SECURITY BOLTS.
- 4. LOUVERS TO HAVE VERTICAL ORIENTATION AND HAVE 100% VISIBILITY BLOCK.
- 5. INSTALL FENCING PER MANUFACTURER RECOMMENDATIONS.
- 6. AMETCO: TEL: 440-951-4300 WWW.AMETCO.COM
- FENCE SHOP DRAWINGS SHALL BE REVIEWED BY DEWBERRY.





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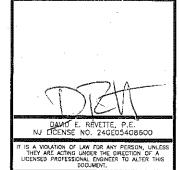
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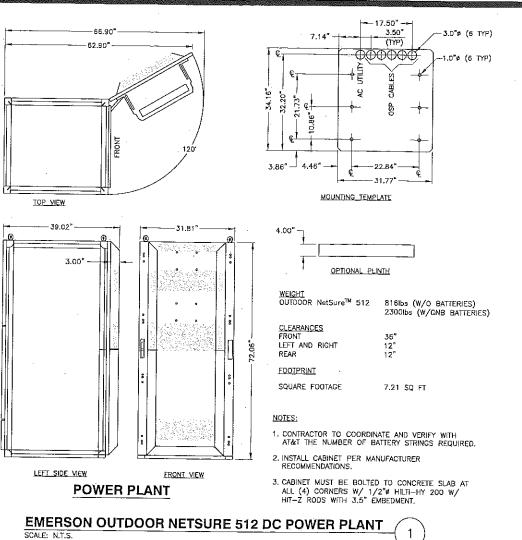
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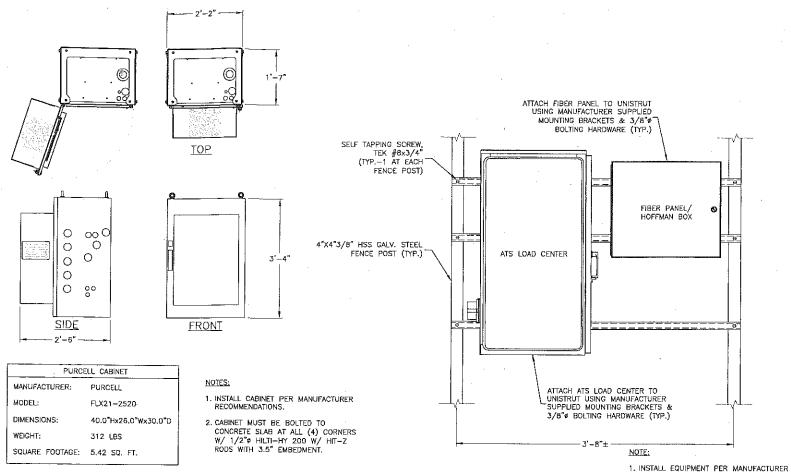
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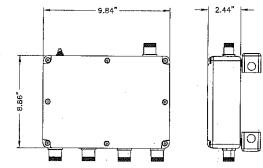
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FLX 21-2520 PURCELL DETAIL






QUADPLEXER MANUFACTURER: COMMSCOPE MODEL NUMBER: CQX782123-DS-43 DIMENSIONS 8.86"Hx9.84"Wx2.44"D WEIGHT: 10.36 LBS

- GROUND EQUIPMENT AND MOUNTS
 PER MANUFACTURER'S
 RECOMMENDATIONS AND AT&T
- CONFIRM REQUIRED EQUIPMENT WITH




QUADPLEXER DETAIL

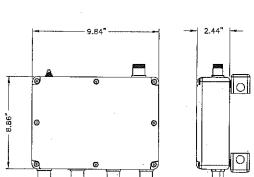

NOTES:

- MOUNT EQUIPMENT PER . MANUFACTURER'S RECOMMENDATIONS.
- LATEST RFDS.

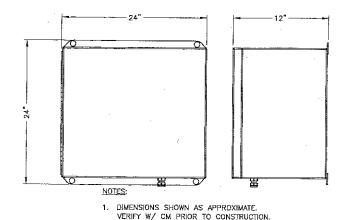

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SITE ADDRESS:

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SHEET TITLE

EQUIPMENT DETAILS

SHEET NUMBER



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RIGHT SIDE VIEW


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FRONT VIEW

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NOTES:

- MANUFACTURER VIA AT&T SUPPLIES THE RRH. CONTRACTOR SHALL SUPPLY ALL OTHER MATERIALS AND INSTALL ALL MOUNTING HARDWARE. ALU INSTALLS RRH AND MAKES CABLE TERMINATIONS.
- MOUNT EQUIPMENT TO UNISTRUT WITH 3/8" WUNISTRUT BOLTING HARDWARE AND SPRING NUTS. TYPICAL FOUR PER BRACKET. CONTRACTOR SHALL SUPPLY.
- 3. NO PAINTING OF THE RRH OR SOLAR SHIELD ALLOWED.

EQUIPMENT MOUNTING DETAILS

SCALE: N.T.S.

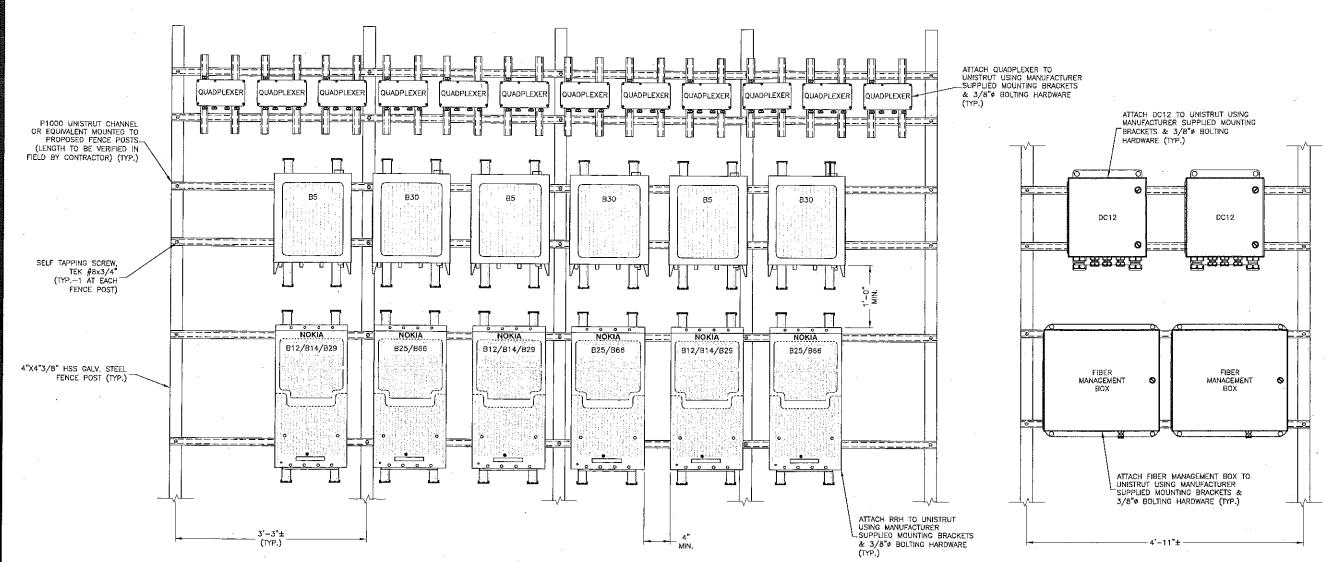

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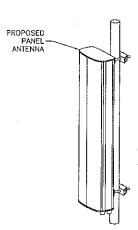
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SHEET TITLE

EQUIPMENT MOUNTING DETAILS

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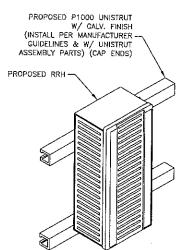
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ANTENNA SF	PECIFICATIONS
MANUFACTURER	COMMSCOPE
MODEL NUMBER	\$BJAH4-1065B-DL
DIMENSIONS (HxWxD)	72.0" x 13.8" x 8.2"
WEIGHT	58.4 LBS

- MOUNT ANTENNA PER MANUFACTURER'S RECOMMENDATIONS.
- 2. WEIGHT DOES NOT INCLUDE MOUNTING BRACKETS.

ANTENNA PIPE MOUNT DETAIL



- 1. MOUNT REMOTE RADIO HEAD PER MANUFACTURER'S RECOMMENDATIONS.
- 2. SIZES INCLUDE SOLAR SHIELD.
- 3. CONTRACTOR TO VERIFY THAT PROPOSED RRH UNITS HAVE ADEQUATE CLEARANCE PER MANUFACTURER'S RECOMMENDATIONS. ADJUST SPACING ON UNISTRUT TO

RRH SPECIFICATIONS						
MANUFACTURER	NOKIA					
MODEL NUMBER	AIRSCALE RRH B25/66 (AHFIB)					
DIMENSIONS (HxWxD)	28.7" x 15.4" x 9.4"					
WEIGHT	88.2 LBS					

RRH SPECIFICATIONS							
MANUFACTURER	NOKIA						
MODEL NUMBER	AIRSCALE RRH B14/12/29 (AHLBBA)						
DIMENSIONS (HxWxD)	30.7" x 17.3" x 11.2"						
WEIGHT	101.2 LBS						

RRH SPECIFICATIONS							
MANUFACTURER	NOKIA						
MODEL NUMBER	AIRSCALE RRH B30 (AHNA)						
DIMENSIONS (HxWxD)	13.7" × 12.5" × 6.3"						
WEIGHT	39.0 LBS						

RRH SPECIFICATIONS							
MANUFACTURER	NOKIA						
MODEL NUMBER	AIRSCALE RRH B5 (AHCA)						
DIMENSIONS (HxWxD)	13.3" x 11.6" x 6.5"						
WEIGHT	36.8 LBS						

REMOTE RADIO HEAD DETAILS

GENERAL CONSTRUCTION NOTES:

- 1. IT IS THE CONTRACTORS RESPONSIBILITY TO VERIFY ANTENNA, TMAS, DIPLEXERS, AND COAX CONFIGURATION, MAKE AND MODELS PRIOR TO
- 2. ALL CONNECTIONS FOR HANGERS, SUPPORTS, BRACING, ETC. SHALL BE INSTALLED PER TOWER MANUFACTURER'S RECOMMENDATIONS.
- 3. CONTRACTOR SHALL REFERENCE THE TOWER STRUCTURAL ANALYSIS/DESIGN DRAWINGS FOR DIRECTIONS ON CABLE DISTRIBUTION/ROUTING.
- 4. ALL OUTDOOR RF CONNECTORS/CONNECTIONS SHALL BE WEATHERPROOFED, EXCEPT THE RET CONNECTORS, USING BUTYL TAPE AFTER INSTALLATION AND FINAL CONNECTIONS ARE MADE. BUTYL TAPE SHALL HAVE A MINIMUM OF ONE-HALF TAPE WIDTH OVERLAP ON EACH TURN AND EACH LAYER SHALL BE WRAPPED THREE TIMES. WEATHERPROOFING SHALL BE SMOOTH WITHOUT BUCKLING. BUTYL BLEEDING IS NOT ALLOWED.
- 5. IF REQUIRED TO PAINT ANTENNAS AND/OR COAX:
- A. TEMPERATURE SHALL BE ABOVE 50° F.
- B. PAINT COLOR MUST BE APPROVED BY BUILDING OWNER/LANDLORD.
- C. FOR REGULATED TOWERS, FAA/FCC APPROVED PAINT IS REQUIRED.
- D. DO NOT PAINT OVER COLOR CODING OR ON EQUIPMENT MODEL NUMBERS.

GENERAL GROUNDING NOTES:

- ALL CABLES SHALL BE GROUNDED WITH COAXIAL CABLE GROUNDING KITS. FOLLOW THE MANUFACTURER'S
- GROUNDING AT THE ANTENNA LEVEL.
- B. GROUNDING AT MID LEVEL, TOWERS WHICH ARE OVER 200'-0", ADDITIONAL CABLE GROUNDING REQUIRED, C. GROUNDING AT BASE OF TOWER PRIOR TO TURNING HORIZONTAL.

 D. GROUNDING OUTSIDE THE EQUIPMENT SHELTER AT ENTRY PORT.
- GROUNDING INSIDE THE EQUIPMENT SHELTER AT THE ENTRY PORT
- ALL PROPOSED GROUNDING BAR DOWNLEADS ARE TO BE TERMINATED TO THE EXISTING ADJACENT GROUNDING BAR DOWNLEADS A MINIMUM DISTANCE OF 4'-O" BELOW GROUNDING BAR. TERMINATIONS MAY BE EXOTHERMIC OR

GENERAL NOTES:

- THE CONTRACTOR SHALL BE RESPONSIBLE FOR VERIFYING THE ANTENNA AND THE COAX CONFIGURATION IS THE CORRECT MAKE AND MODELS, PRIOR TO
- 2. DISTANCE FROM RRH TO SURGE ARRESTOR TO BE A MAXIMUM OF 5 METERS.
- 3. ALL CONNECTIONS FOR HANGERS, SUPPORTS, BRACING, ETC. SHALL BE INSTALLED PER TOWER MANUFACTURER'S SPECIFICATION AND RECOMMENDATIONS.
- 4. CONTRACTOR SHALL REFERENCE THE TOWER STRUCTURAL ANALYSIS/DESIGN DRAWINGS FOR DIRECTIONS ON CABLE DISTRIBUTION/ROUTING.

ANTENNA MOUNTING NOTES:

- 1. DESIGN AND CONSTRUCTION OF ANTENNA SUPPORTS SHALL CONFORM TO CURRENT ANSI/TIA-222 OR APPLICABLE LOCAL CODES.
- 2. ALL STEEL MATERIALS SHALL BE GALVANIZED AFTER FABRICATION IN ACCORDANCE WITH ASTM A123 "ZINC (HOT-DIP GALVANIZED) COATINGS ON IRON AND STEEL PRODUCTS", UNLESS NOTED OTHERWISE.
- 3. ALL BOLTS, ANCHORS AND MISCELLANEOUS HARDWARE SHALL BE GALVANIZED IN ACCORDANCE WITH ASTM A153 "ZINC-COATING (HOT-DIP) ON IRON AND STEEL HARDWARE", UNLESS NOTED OTHERWISE.
- 4. DAMAGED GALVANIZED SURFACES SHALL BE REPAIRED BY COLD GALVANIZING IN ACCORDANCE WITH ASTM A780.
- 5. ALL ANTENNA MOUNTS SHALL BE INSTALLED WITH LOCK NUTS, DOUBLE NUTS AND SHALL BE TORQUED TO MANUFACTURER'S RECOMMENDATIONS.
- 6. CONTRACTOR SHALL INSTALL ANTENNA PER MANUFACTURER'S RECOMMENDATION FOR INSTALLATION AND GROUNDING.
- 7. ALL UNUSED PORTS ON ANY ANTENNAS SHALL BE TERMINATED WITH A 50-OHM LOAD TO ENSURE ANTENNAS PERFORM AS DESIGNED.
- 8. PRIOR TO SETTING ANTENNA AZIMUTHS AND DOWNTILTS, ANTENNA CONTRACTOR SHALL CHECK THE ANTENNA MOUNT FOR TIGHTNESS AND ENSURE THAT THEY ARE PLUMB. ANTENNA AZIMUTHS SHALL BE SET FROM TRUE NORTH AND BE ORIENTED WITHIN +/- 5% AS DEFINED BY THE RFDS. ANTENNA DOWNTILTS SHALL BE WITHIN +/- 0.5% AS DEFINED BY THE RFDS. REFER TO ND-00246.
- 9. JUMPERS FROM THE TMA'S MUST TERMINATE TO OPPOSITE POLARIZATION'S IN EACH SECTOR.
- 10. CONTRACTOR SHALL RECORD THE SERIAL #, SECTOR, AND POSITION OF EACH ACTUATOR INSTALLED AT THE ANTENNAS AND PROVIDE THE INFORMATION TO AT&T.
- 11. TMA'S SHALL BE MOUNTED ON PIPE DIRECTLY BEHIND ANTENNAS AS CLOSE TO ANTENNA AS FEASIBLE IN A VERTICAL POSITION.
- 12. ANTENNAS SHALL HAVE A 4'-0" MIN CENTER TO CENTER HORIZONTAL SEPARATION.

TORQUE REQUIREMENTS:

- 1. ALL RF CONNECTIONS SHALL BE TIGHTENED BY A TORQUE WRENCH.
- 2. ALL RF CONNECTIONS, GROUNDING HARDWARE AND ANTENNA HARDWARE SHALL HAVE A TORQUE MARK INSTALLED IN A CONTINUOUS STRAIGHT LINE FROM BOTH SIDES OF THE CONNECTION.
- A. RF CONNECTION, BOTH SIDES OF THE CONNECTOR. B. GROUNDING AND ANTENNA HARDWARE ON THE NUT SIDE STARTING FROM THE THREADS TO THE SOLID SURFACE, EXAMPLE OF SOLID SURFACE: GROUND BAR, ANTENNA BRACKET METAL.
- 3. ALL 8M ANTENNA HARDWARE SHALL BE TIGHTENED TO 9 LB-FT (12 NM).
- 4. ALL 12M ANTENNA HARDWARE SHALL BE TIGHTENED TO 43 LB-FT (58 NM).
- 5. ALL GROUNDING HARDWARE SHALL BE TIGHTENED UNTIL THE LOCK WASHER COLLAPSES AND THE GROUNDING HARDWARE IS NO LONGER
- 6. ALL DIN TYPE CONNECTIONS SHALL BE TIGHTENED TO 18-22 LB-FT (24.4 29.8 NM).
- 7. ALL N TYPE CONNECTIONS SHALL BE TIGHTENED TO 15-20 LB-IN (1.7 2.3 NM).

FIBER & POWER CABLE MOUNTING NOTES:

- 1. THE FIBER OPTIC TRUNK CABLES SHALL BE INSTALLED INTO CONDUITS, CHANNEL CABLE TRAYS, OR CABLE TRAY. WHEN INSTALLING FIBER OPTIC TRUNK CABLES INTO A CABLE TRAY SYSTEM, THEY SHALL BE INSTALLED INTO AN INTER DUCT AND A PARTITION BARRIER SHALL BE INSTALLED BETWEEN THE 600 VOLT CABLES AND THE INTER DUCT IN ORDER TO SEGREGATE CABLE TYPES. OPTIC FIBER TRUNK CABLES SHALL HAVE APPROVED CABLE RESTRAINTS EVERY (60) SIXTY FEET AND SECURELY FASTENED TO THE CABLE TRAY SYSTEM. NFPA 70 (NEC) ARTICLE 770 RULES SHALL APPLY,
- 2. THE TYPE TC-ER CABLES SHALL BE INSTALLED INTO CONDUITS, CHANNEL CABLE TRAYS, OR CABLE TRAY AND SHALL BE SECURED AT INTERVALS NOT EXCEEDING (6) SIX FEET. AN EXCEPTION; WHERE TYPE TC-ER CABLES ARE NOT SUBJECT TO PHYSICAL DAMAGE, CABLES SHALL BE PERMITTED TO MAKE A TRANSITION BETWEEN CONDUITS, CHANNEL CABLE TRAYS, OR CABLE TRAY WHICH ARE SERVING UTILIZATION EQUIPMENT OR DEVICES, A DISTANCE (6) SIX FEET SHALL NOT BE EXCEEDED WITHOUT CONTINUOUS SUPPORTING. NFPA 70 (NEC) ARTICLES 336 AND 392 RULES SHALL APPLY.
- 3. WHEN INSTALLING OPTIC FIBER TRUNK CABLES OR TYPE TC-ER CABLES INTO CONDUITS, NFPA 70 (NEC) ARTICLE 300 RULES SHALL



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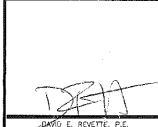
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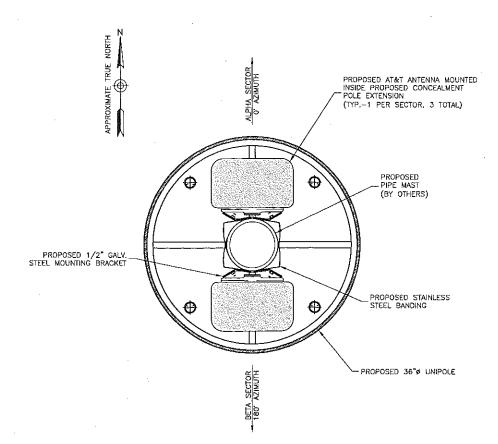
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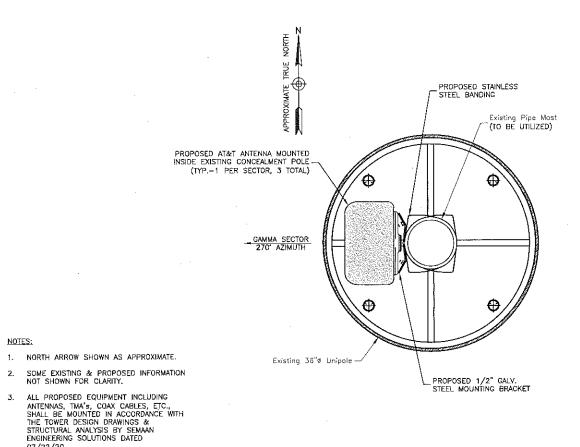
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SHEET TITLE

ANTENNA & RRH DETAILS & NOTES



85'-0"± CENTERLINE



55'-0"± CENTERLINE

PROPOSED ANTENNA PLANS SCALE: 3/4"=1' FOR 11"x17" 1 1/2"=1' FOR 22"x34"

INSTALL ANTENNAS, COAX & MOUNT PER MANUFACTURER'S RECOMMENDATIONS.

5. CONTRACTOR TO CONFIRM ANTENNA FITMENT PRIOR TO INSTALLATION.

NOTES:



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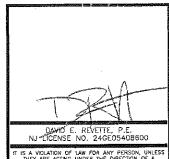


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Dewberry*

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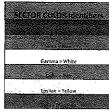
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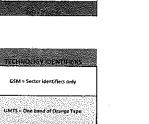
1167 OCEAN AVE SEA BRIGHT, NJ 07760 MONMOUTH COUNTY


SHEET TITLE

PROPOSED ANTENNA PLANS

LTE COLOR KEY





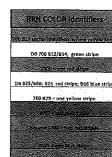

LTE COLOR CODING KEY

	X X X X X X X X X X X X X X X X X X X	
· · · · · · · · · · · · · · · · · · ·	RET	
	REF Control Cable	
Tower Ground	Outsplear Control Cont	
A.		
	Safety Samuel Safety Samuel Safety Sa	
	Power Plant	

NOTES:

1. RF PLUMBING DIAGRAM BASED ON NWLO5867 RFDS VERSION 1.00 DATED 02/11/2020.

LTE 700 / 850 / 1900 / AWS / WCS

2. CONTRACTOR TO VERIFY FINAL RFDS AND CABLE LENGTHS PRIOR TO CONSTRUCTION.

PLUMBING DIAGRAM SCALE: N.T.S.

	FINAL EQUIPMENT CONFIGURATION									
SECTOR	BAND	ANTENNA	SIZE (INCHES) (LxWxD)	RAD. CENTER	AZIMUTH	MECHANICAL DOWNTILT	QUADPLEXER ON TOWER	RRH AT EQUIPMENT	QUADPLEXER AT EQUIPMENT	COAX/CABLES
ALPHA	LTE 700/850/1900/ AWS/WCS	COMMSCOPE SBJAH4-1D65B-DL	72.0x13.8x8.2	85'0"	0.	0	(4) CQX782123-DS-43	(1) B14/12/29 AHLBBA (1) B5 AHCA (1) B25/66 AHFIB (1) B30 AHNA	(4) CQX782123-DS-43	(3) 10mm FIBER (4) 7/8 Ø COAX (1) RET CABLE
BETA	LTE 700/850/1900/. AWS/WCS	COMMSCOPE SBJAH4-1D65B-DL	72.0x13.8x8.2	85"-0"	/180*	0.	(4) CQX782123-DS-43	(1) B14/12/29 AHLBBA (1) B5 AHCA (1) B25/56 AHFIB (1) B30 AHNA	(4) CQX782123-DS-43	(3) 10mm FIBER* (4) 7/8*ø COAX (1) RET CABLE
GAMMA	LTE 700 850/1900/ AWS/WCS	COMMSCOPE SBJAH41D65BDL	72.0x13.8x8.2	55'-0"	270	0.	(4) CQX782123-DS-43	(1) B14/12/29 AHLBBA (1) B5 AHCA (1) B25/66 AHFIB (1) B30 AHNA	(4) CQX782123-DS-43	(3) 10mm FIBER (4) 7/8 ø COAX (1) RET CABLE

NOTES:

- 1. FINAL EQUIPMENT CONFIGURATION BASED ON NWLO5867 RFDS VERSION 1.00 DATED 02/11/2020.
- 2. CONTRACTOR TO VERIFY FINAL RFDS AND CABLE LENGTHS PRIOR TO CONSTRUCTION.

FINAL EQUIPMENT CONFIGURATION (3



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D	12/04/20	ISSUED FOR REMEW
С	12/30/19	ISSUED FOR REVIEW
В	10/30/19	ISSUED FOR REVIEW
Α	10/22/19	ISSUED FOR REVIEW

Dewberry*

Dewberry Engineers Inc.

900 PARSIPPANY ROAD SUITE 301 PARSIPPANY, NJ 97054 PHONE: 973.739.9400 FAX: 973.739.9710 COA 24GA28047600



	DOGUMENT	
V.	DRAWN BY:	FG
	REVIEWED BY:	BSH
	CHECKED BY:	DER
	PROJECT NUMBER:	50110598
	JOB NUMBER:	50110611
	SITE ADDRESS:	


1167 OCEAN AVE SEA BRIGHT, NJ 07760 MONMOUTH COUNTY

SHEET TITLE

COLOR CODING, PLUMBING DIAGRAM & B.O.M.

SHEET NUMBER

C - 10

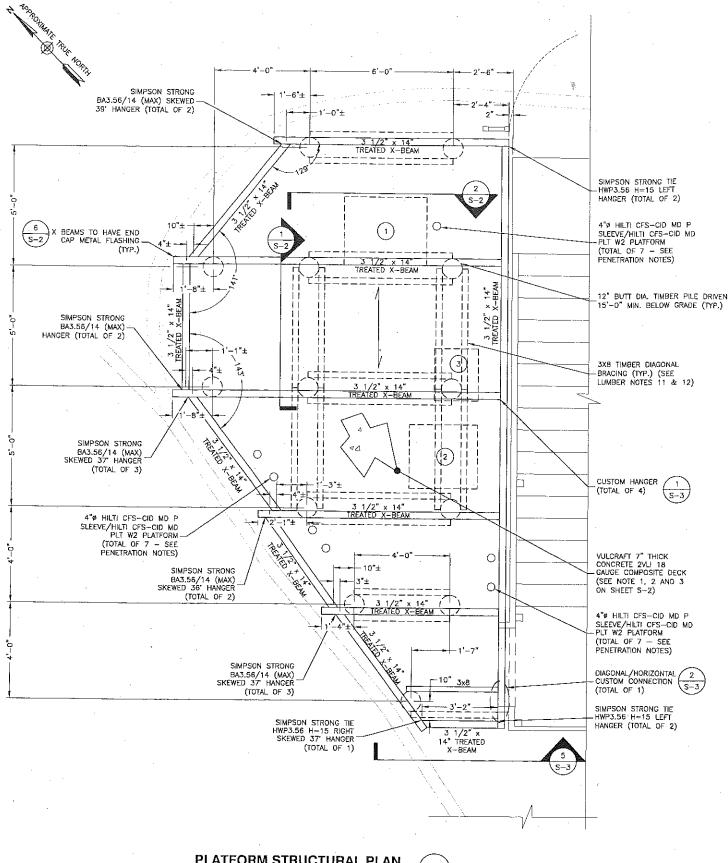

PLATFORM STRUCTURAL PLAN SCALE: 1/4"=1" FOR 11"v17

1/2 =1 FOR 22 x34"



LUMBER NOTES:

- ALL WORKMANSHIP AND MATERIAL SHALL CONFORM TO THESE DRAWINGS AND THE REQUIREMENTS OF THE 2018 INTERNATIONAL BUILDING CODE, NJ EDITION, AND LOCAL REQUIREMENTS.
- ALL WOOD SHALL BE FASTENED AS SHOWN ON THESE DRAWINGS WHERE THE CONNECTION IS NOT DETAILED, THE CONNECTION MUST CONFORM WITH THE FASTENING SCHEDULE AS SHOWN IN THE '2018 IBC, NJ EDITION.
- 3. WOOD SHALL BE IDENTIFIED BY THE SPECIFIC GRADE MARK OF THE SOUTHER PINE INSPECTION BUREAU AND THE WEST COAST LUMBER INSPECTION BUREAU.
- PLYWOOD SHALL BE IDENTIFIED BY THE SPECIFIC GRADE MARK OF THE AMERICAN PLYWOOD ASSOCIATION.
- 5. PRESERVATIVE TREATMENT SHALL BE IN ACCORDANCE WITH THE STANDARDS OF THE AMERICAN WOOD PRESERVERS ASSOCIATION
- 6. MOISTURE CONTENT FOR ALL WOOD MATERIAL SHALL NOT EXCEED 19%.
- ALL WOOD AND PLYWOOD SHALL BE FREE OF ROT, HIGH MOISTURE CONTENT, INSECT INFESTATION, WAKES, SHAKES, WARPS, ETC.
- 8. ALL MATERIAL SHALL BE PROPERLY DELIVERED TO THE SITE AND STORED ABOVE GROUND, PROTECTED FROM THE WEATHER.
- 9. WOOD SCREWS GALVANIZED, SIZE AND LENGTH SHOWN ON DRAWINGS.
- 10. NAILS GALVANIZED, COMMON WIRE.

C. 3.5" MIN VERTICAL BOLT SPACING

- 11. DIAGONAL BRACE MEMBERS SHALL BE SOUTHERN PINE TIMBER No. 1 OR APPROVED EQUAL (G=0.55).
- 12. 3X8 DIAGONAL BRACE BOLT CONNECTIONS SHALL MEET THE FOLLOWING CRITERIA

 A. 1.5" MIN EDGE DISTANCE B. 5" MIN END DISTANCE OF 3XB

SLAB PENETRATION NOTES:

- 1. DISTANCE BETWEEN HILTI SLEEVE LOCATIONS SHALL BE A MINIMUM OF 8"
- 2. DISTANCE BETWEEN HILTI SLEEVE LOCATIONS AND FENCE BASE PLATE SHALL
- 3. HILTI SLEEVES SHALL BE PLACED SO THEY ARE JUST WITHIN THE FENCE PERIMETER
- 4. ALL HILTI SLEEVES TO BE INSTALLED PER HILTI RECOMMENDATIONS

SIMPSON STRONG TIE HANGER NOTES:

- 1) ALL HANGERS TO BE HOT DIP GALVANIZED
- 2) ALL HANGERS TO BE INSTALLED PER SIMPSON STRONG TIE RECOMMENDATIONS.
- CARRIED MEMBER TO BE BEVEL CUT WHERE SKEWED HANGERS ARE USED, PER SIMPSON STRONG TIE RECOMMENDATIONS
- 4) CONTRACTOR TO VERIFY AND CONFIRM HANGER SKEW
- 5) BA3.56/14 (MAX) HANGERS TO BE FASTENED WITH: (6) 16d COMMON (0.165" X 3.5") NAILS IN TOP (6) 16d COMMON (0.165" X 3.5") NAILS IN FACE (8) 10d COMMON (0.148" X 1.5") NAILS IN JOIST
- 6) HWP3.56 H=14 HANGERS TO BE FASTENED WITH: (6) 16d COMMON (0.165" X 3.5") NAILS IN TOP (6) 16d COMMON (0.165" X 3.5") NAILS IN FACE (8) 10d COMMON (0.148" X 1.5") NAILS IN JOIST

X-BEAM NOTES:

- 1) X BEAMS MANUFACTURED BY ROSBORO (888) 393 2304 2) X-BEAMS TO BE TREATED WITH HI-CLEAR II

TEM	TQ T
HWP3.56 H=14 LEFT	2
HWP3,56 H=14 RIGHT SKEWED 37	1
BA3.56/14 (MAX) SKEWED 37*	3
BA3.56/14 (MAX) SKEWED 36'	2
BA3.56/14 (MAX) SKEWED 39"	2
BA3.56/14 (MAX)	2

5. EQUIPMENT	PPC/TELCO RACK TOTAL EQUIPMENT DEAD LO	1	150 LBS 4678 LBS	
4. EQUIPMENT	RRH/DC SURGE RACK	1	1067 L8S	
EQUIPMENT	FLX PURCELL CABINET	1	312 LBS	
2. EQUIPMENT	DC POWER PLANT CABINET	1	2300 L8S	
1. EQUIPMENT	20KW DC GENERATOR	1	849 LBS	
DESIGN SPECIFICATIONS:	MODEL.	QUANTITY*	WEIGHT	

LOCATION & INSTALLATION OF PROPOSED ELEVATED PLATFORM & EQUIPMENT SHALL BE INSTALLED IN ACCORDANCE WITH THE STRUCTURAL ANALYSIS BY DEWBERRY ENGINEERS INC. DATED 12/04/20.



New Cingular Wireless PCS, LLC One AT&T Way Bedminster, NJ 07921



SEA BRIGHT BOROUGH HALL W-5867

	CONSTE	RUCTION DRAWINGS
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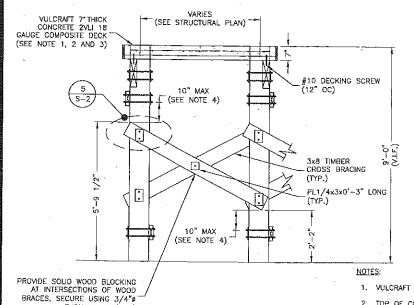


DRAWN BY:	FC
REVIEWED BY:	BSI
CHECKED BY:	DEF
PROJECT NUMBER:	50110598
JOB NUMBER:	5011061
SITE ADDRESS:	

1167 OCEAN AVE SEA BRIGHT, NJ 07760 MONMOUTH COUNTY

SHEET TITLE

EQUIPMENT PLATFORM STRUCTURAL PLAN



TIMBER PILE BRACING DETAIL

SCALE: 1/4"=1' FOR 11"x17"

1/2"=1' FOR 22"x34"


THRU BOLTS (TYP.)


VULCRAFT 7" THICK CONCRETE 2VLI 18 GAUGE COMPOSITE DECK VARIES (SEE STRUCTURAL PLAN) ~ (SEE NOTE 1, 2 AND 3) Jana Jana Jana Jana 1'-0"(TYP.) #10 DECKING SCREW (12" OC)-3x8 TIMBER CROSS BRACING (TYP.) -4 1/2" 2. TOP OF CONCRETE DECK PROTECTED WITH SILOXA—TEK 8500 PENETRATING CONCRETE SEALER PROVIDE SOLID WOOD BLOCKING AT INTERSECTIONS OF WOOD PL1/4x3x0'-3" LONG (TYP.) BRACES, SECURE USING 3/4"¢ THRU BOLTS (TYP.)


1. VULCRAFT METAL DECK WITH G90 GALVANIZED COATING

3. 16 GAUGE POUR STOP TO BE USED AROUND PERIMETER OF RAISED PLATFORM


4. CONTRACTOR TO MINIMIZE BRACING SPACING PER FIELD CONDITIONS. MINIMUM OF 4" AND MAXIMUM OF 10" $^{\circ}$

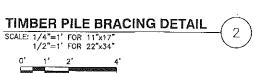


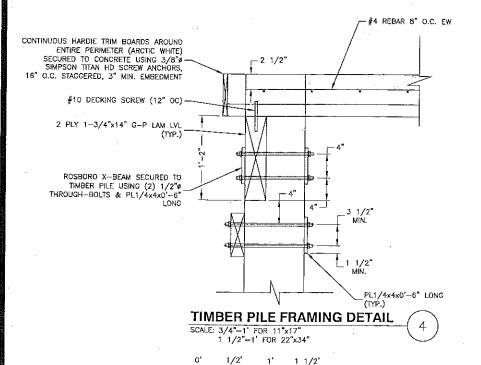


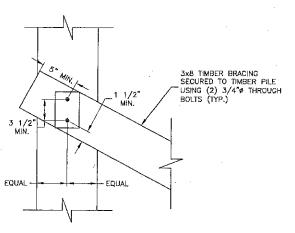


TIMBER PILE BRACING DETAIL SCALE: 3/4"=1' FOR 11"x17" 1 1/2"=1' FOR 22"x34"

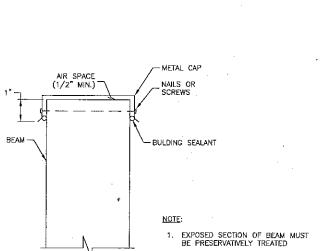

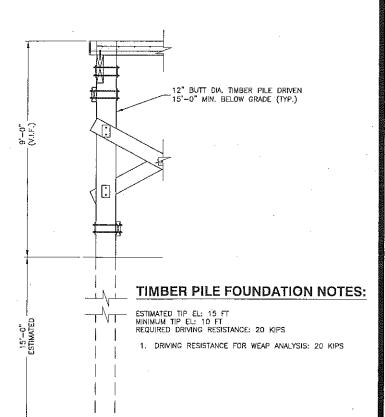

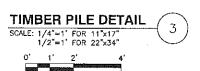

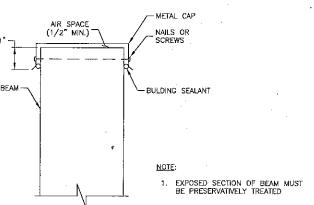

END CAP FOR EXPOSED BEAMS OR VERTICAL MEMBERS DETAIL SCALE: N.T.S.



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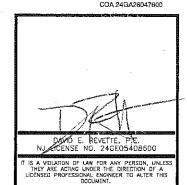


SEA BRIGHT BOROUGH HALL W-5867

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Dewberry*

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DRAWN BY:	FG
REVIEWED BY:	BSH
CHECKED BY:	DER
PROJECT NUMBER	50110508

50110611 JOB NUMBER:

SITE ADDRESS:


1167 OCEAN AVE SEA BRIGHT, NJ 07760 MONMOUTH COUNTY


SHEET TITLE

PLATFORM STRUCTURAL DETAILS I

SHEET NUMBER

S-2

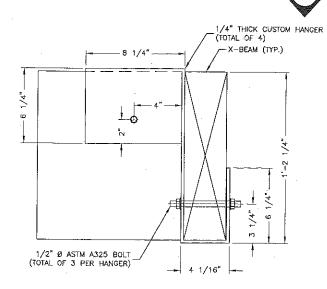

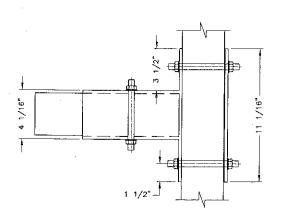


CUSTOM HANGER DETAIL

SCALE: 1 1/2"=1" FOR 11"x17"

3"=1" FOR 22"x34"

SECTION A-A

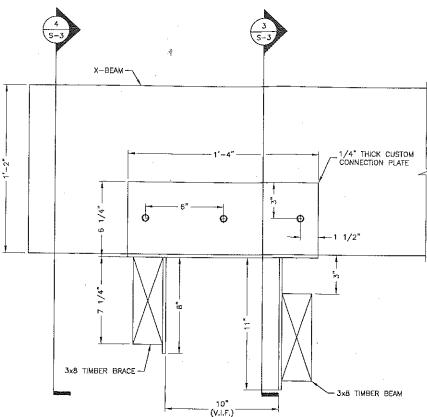


DIAGONAL/HORIZONTAL CUSTOM CONNECTION

SCALE: 1 1/2"=1' FOR 11"x17"

3"=1' FOR 22"x34"




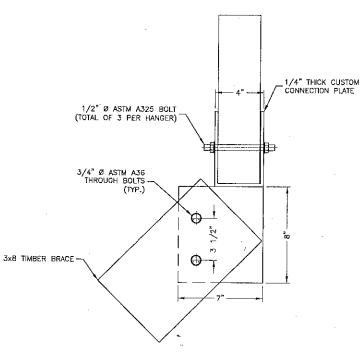



CONNECTION DETAIL

SCALE: 1 1/2"=1' FOR 11"x17"

3"=1' FOR 22"x34"

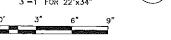

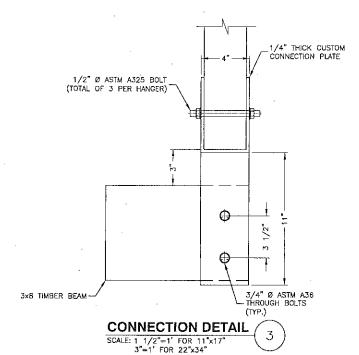

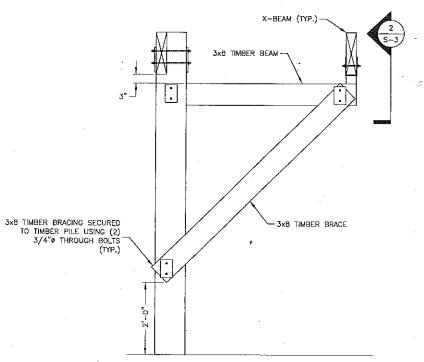

X-BEAM CANTILEVER BRACE ELEVATION

SCALE: 3/8"=1' FOR 11"x17"
3/4"=1' FOR 22"x34"





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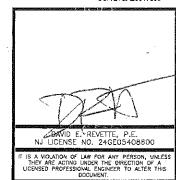
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Dewberry

Dewberry Engineers Inc.

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DRAWN BY:	FG
REVIEWED BY:	BSH
CHECKED BY:	DER

PROJECT NUMBER: 50110598

JOB NUMBER: 50110611

SITE ADDRESS:


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SHEET TITLE

PLATFORM STRUCTURAL DETAILS II

SHEET NUMBER

S-3



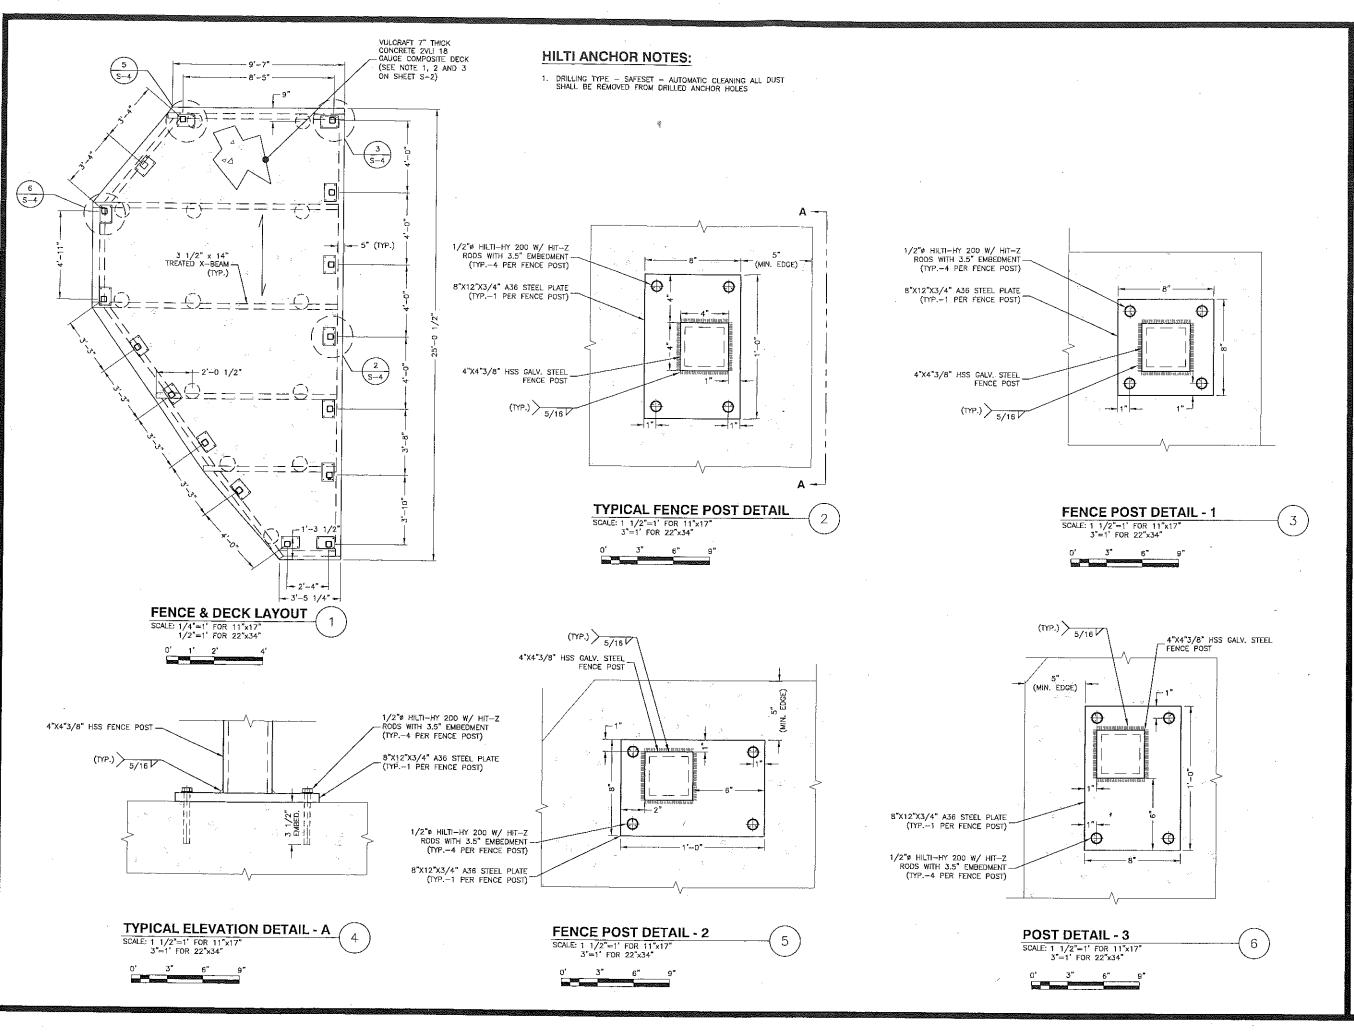

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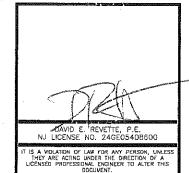
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Α	10/22/19	ISSUED FOR REVIEW

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DRAWN BY: FG

REVIEWED BY: BSH

CHECKED BY: DER

PROJECT NUMBER: 50110598

JOB NUMBER: 50110611

SITE ADDRESS:

1167 OCEAN AVE SEA BRIGHT, NJ 07760


MONMOUTH COUNTY

SHEET TITLE

FENCE LAYOUT & CONNECTION DETAILS

SHEET NUMBER

S - 4

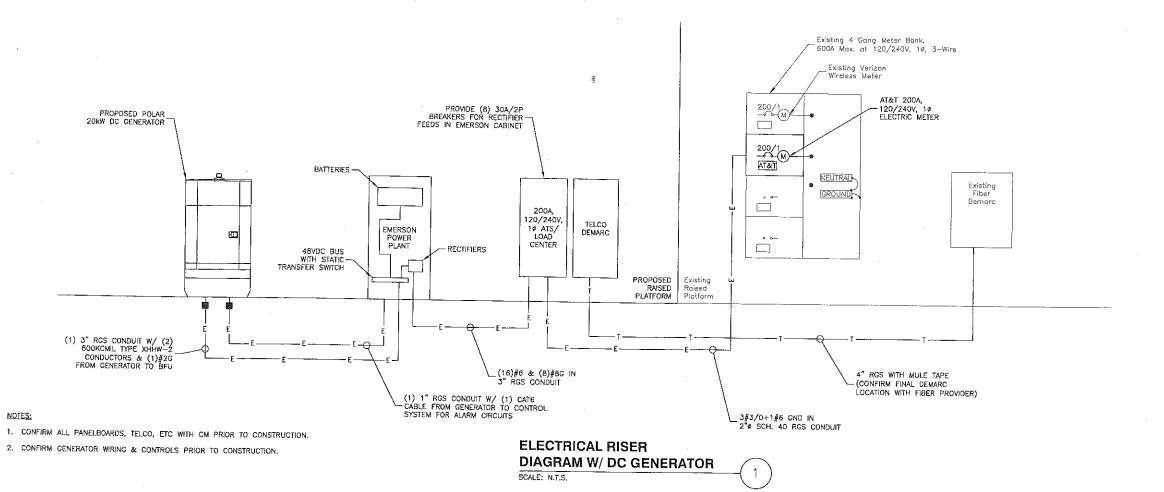

GENERAL ELECTRICAL NOTES

- SUBMITTAL OF BID INDICATES CONTRACTOR IS COGNIZANT OF ALL JOB SITE CONDITIONS AND WORK TO BE PERFORMED UNDER THIS CONTRACT.
- CONTRACTOR SHALL PERFORM ALL VERIFICATION OBSERVATION TESTS, AND EXAMINATION WORK PRIOR TO THE ORDERING OF THE ELECTRICAL EQUIPMENT AND THE ACTUAL CONSTRUCTION. CONTRACTOR SHALL ISSUE A WRITTEN NOTICE OF ALL FINDINGS TO THE ARCHITECT LISTING ALL MALFUNCTIONS, FAULTY EQUIPMENT AND DISCREPANCIES.
- HEIGHTS SHALL BE VERIFIED WITH OWNER PRIOR TO INSTALLATION.
- 4. THESE PLANS ARE DIAGRAMMATIC ONLY, FOLLOW AS CLOSELY AS POSSIBLE.
- 5. EACH CONDUCTOR OF EVERY SYSTEM SHALL BE PERMANENTLY TAGGED IN EACH PANELBOARD, PULLBOX, J-BOX, SWITCH BOX, ETC., IN COMPLIANCE WITH OCCUPATIONAL SAFETY AND HEALTH ACT (O.S.H.A.)
- 6. CONTRACTOR SHALL PROVIDE ALL LABOR, MATERIALS, INSURANCE, EQUIPMENT, INSTALLATION, CONSTRUCTION TOOLS, TRANSPORTATION, ETC., FOR A COMPLETE AND PROPERLY OPERATIVE SYSTEM ENERGIZED THROUGHOUT AND AS INDICATED ON DRAWINGS, AS SPECIFIED HEREIN AND/OR AS OTHERWISE REQUIRED.
- 7. ALL MATERIALS AND EQUIPMENT SHALL BE NEW AND IN PERFECT CONDITION WHEN INSTALLED AND SHALL BE OF THE BEST GRADE AND OF THE SAME MANUFACTURER THROUGHOUT FOR EACH CLASS OR GROUP OF EQUIPMENT. MATERIALS SHALL BE LISTED AND APPROVED BY UNDERWRITER'S LABORATORY AND SHALL BEAR THE INSPECTION LABEL "J" WHERE SUBJECT TO SUCH APPROVAL. MATERIALS SHALL MEET WITH APPROVAL OF THE DIVISION OF INDUSTRIAL SAFETY AND ALL GOVERNING BODIES HAVING JURISDICTION. MATERIALS SHALL BE MANUFACTURED IN ACCORDANCE WITH

- APPLICABLE STANDARDS ESTABLISHED BY ANSI, NEMA AND NBFU.
- CONTRACTOR SHALL CARRY OUT HIS WORK IN ACCORDANCE WITH ALL GOVERNING STATE, COUNTY AND LOCAL CODES AND O.S.H.A.
- CONTRACTOR SHALL SECURE ALL NECESSARY BUILDING PERMITS AND PAY ALL REQUIRED FEES
- 10. COMPLETE JOB SHALL BE GUARANTEED FOR A PERIOD OF ONE (1) YEAR AFTER THE DATE OF JOB ACCEPTANCE BY OWNER. ANY WORK, MATERIAL OR EQUIPMENT FOUND TO BE FAULTY DURING THAT PERIOD SHALL BE CORRECTED AT ONCE, UPON WRITTEN NOTIFICATION, AT THE EXPENSE OF THE CONTRACTOR.
- ALL CONDUIT ONLY (C.O.) SHALL HAVE A PULL WIRE OR ROPE.
- 12. PROVIDE PROJECT MANAGER WITH ONE SET OF COMPLETE ELECTRICAL "AS INSTALLED" DRAWINGS AT THE COMPLETION OF THE JOB, SHOWING ACTUAL DIMENSIONS, ROUTINGS, AND CIRCUITS
- ALL BROCHURES, OPERATING MANUALS, CATALOGS, SHOP DRAWINGS, ETC. SHALL BE TURNED OVER TO OWNER AT JOB COMPLETION.
- 14. USE T-TAP CONNECTIONS ON ALL MULTI-CIRCUITS WITH COMMON NEUTRAL CONDUCTOR FOR LIGHTING FIXTURE.
- ALL CONDUCTORS SHALL BE COPPER.
- 16. ALL CIRCUIT BREAKERS, FUSES AND ELECTRICAL EQUIPMENT SHALL HAVE AN INTERRUPTING RATING NOT LESS THE MAXIMUM SHORT CIRCUIT CURRENT TO WHICH THEY MAY BE SUBJECTED
- 17. THE ENTIRE ELECTRICAL INSTALLATION SHALL BE GROUNDED AS REQUIRED BY NEC.
- 18. PATCH, REPAIR AND PAINT ANY AREA THAT HAS

- ANSI, BEEN DAMAGED IN THE COURSE OF THE ELECTRICAL WORK.
 - 19. IN DRILLING HOLES INTO CONCRETE WHETHER FOR FASTENING OR ANCHORING PURPOSES, OR PENETRATIONS THROUGH THE FLOOR FOR CONDUIT RUNS, M PIPE RUNS, ETC., IT MUST BE CLEARLY UNDERSTOOD THAT TENDONS AND/OR REINFORCING STEEL WILL NOT BE DRILLED INTO, CUT OR DAMAGED UNDER ANY CIRCUMSTANCES.
 - 20. LOCATION OF TENDONS AND/OR REINFORCING STEEL ARE NOT DEFINITELY KNOWN AND, THEREFORE, MUST BE SEARCHED FOR BY APPROPRIATE METHODS AND EQUIPMENT VIA X—RAY OR OTHER DEVICES THAT CAN ACCURATELY LOCATE THE REINFORCING AND/OR STEEL TENDONS.
 - 21. PENETRATIONS IN FIRE RATED WALLS SHALL BE INTERNATIONAL BUILDING CODE 2009, NEW JERSEY FORTION
 - 22. WIRE AND CABLE CONDUCTORS SHALL BE COPPER #12 AWG MINIMUM UNLESS SPECIFICALLY STATED OTHERWISE ON DRAWINGS.
 - VERIFY ALL CONDUIT ROUTING W/OWNER REP. & C.M.
 - 24. ALL MATERIALS SHALL BE U.L. LISTED.
 - 25. CONDUIT:
 - q. RIGID CONDUIT SHALL BE U.L. LABEL GALVANIZED ZINC COATED WITH ZINC INTERIOR AND SHALL BE USED WHEN INSTALLED IN OR UNDER CONCRETE SLABS, IN CONTACT WITH THE EARTH, UNDER PUBLIC ROADWAYS, IN MASONRY WALLS OR EXPOSED ON BUILDING EXTERIOR. RIGID CONDUIT IN CONTACT WITH EARTH SHALL BE 1/2 LAPPED WRAPPED WITH HUNTS WRAP PROCESS NO. 3.
 - ELECTRICAL METALLIC TUBING SHALL HAVE U.L. LABEL, FITTINGS SHALL BE GLAND RING COMPRESSION TYPE. EMT SHALL BE USED

ONLY FOR INTERIOR RUNS.

- c. FLEXIBLE METALLIC CONDUIT SHALL HAVE U.L. LISTED LABEL AND MAY BE USED WHERE PERMITTED BY CODE. FITTINGS SHALL BE "JAKE" OR "SQUEEZE" TYPE, SEAL TIGHT FLEXIBLE CONDUIT. ALL CONDUIT IN EXCESS OF SIX FEET IN LENGTH SHALL HAVE FULL SIZE GROUND WIRE.
- d. CONDUIT RUNS MAY BE SURFACE MOUNTED IN CEILINGS OR WALLS UNLESS INDICATED OTHERWISE. CONDUIT INDICATED SHALL RUN PARALLEL OR AT RIGHT ANGLES TO CEILING, FLOOR OR BEAMS. VERIFY EXACT ROUTING OF ALL EXPOSED CONDUIT WITH ARCHITECT PRIOR TO INSTALLING.
- ALL ELECTRICAL EQUIPMENT SHALL BE LABELED WITH PERMANENT ENGRAVED PLASTIC LABELS.
- COORDINATE THE ELECTRICAL SERVICE SHUTDOWN WITH BUILDING OWNER.
- 28. GROUNDING SYSTEM RESISTANCE SHALL NOT EXCEED 5 OHMS. IF THE RESISTANCE VALUE IS EXCEEDED, NOTIFY THE OWNER FOR FURTHER INSTRUCTION ON METHODS FOR REDUCING THE RESISTANCE VALUE. SUBMIT TEST REPORTS AND FURNISH TO DISPATCH COMMUNICATIONS ONE COMPLETE SET OF PRINTS SHOWING "INSTALLED WORK".
- 29. UPON COMPLETION OF WORK, CONDUCT CONTINUITY, AND FALL POTENTIAL GROUNDING TESTS FOR APPROVAL. SUBMIT TEST REPORTS TO PROJECT MANAGER. CLEAN PREMISES OF ALL DEBRIS RESULTING FROM WORK AND LEAVE WORK IN A COMPLETE AND UNDAMAGED CONDITION.
- 30. ALL WALL PENETRATIONS SHALL BE FIRE STOPPED WITH FS-ONE HIGH PERFORMANCE INTUMESCE FIRE STOP BY HILTI OR APPROVED EQUAL. INSTALL PER MANUFACTURERS RECOMMENDATIONS.

ELECTRICAL AND TELEPHONE GENERAL NOTES:

- FOLLOWING COMPLETION OF WORK, PROVIDE OWNER WITH AS—BUILT DRAWINGS SHOWING TELEPHONE AND ELECTRIC LOCATIONS.
- 2. WORK SHALL CONFORM TO THE NATIONAL ELECTRICAL CODE, NEC 2011.
- COORDINATE WITH UTILITY AND LOCAL ELECTRICAL INSPECTOR FOR FINAL POWER CONNECTION.
- UTILITY WILL SUPPLY METER. COORDINATE WITH UTILITY FOR METER TYPE AND INTERCONNECTION.
- CONTRACTOR SHALL CONTACT "GARDEN STATE UNDERGROUND PLANT LOCATION SERVICE" AT 1-800-272-1000 AND LOCATE ALL EXISTING UTILITIES WITHIN THE AREA OF WORK PRIOR TO THE START OF ANY FYCAVATION
- 6. SEE PAGE E-2 FOR GENERAL GROUNDING NOTES.
- COORDINATE WITH LOCAL TELEPHONE COMPANY FOR ALL ROUTING AND DESIGN.
- 8. CONTRACTOR TO VERIFY CONTROL WIRING SIZE WITH GENERATOR MANUFACTURER PRIOR TO CONSTRUCTION.
- 9. CONTRACTOR TO CONFIRM STUB UP LOCATIONS OF WIRING CONDUITS PRIOR TO CONSTRUCTION.



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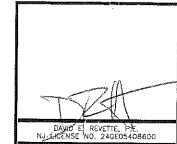
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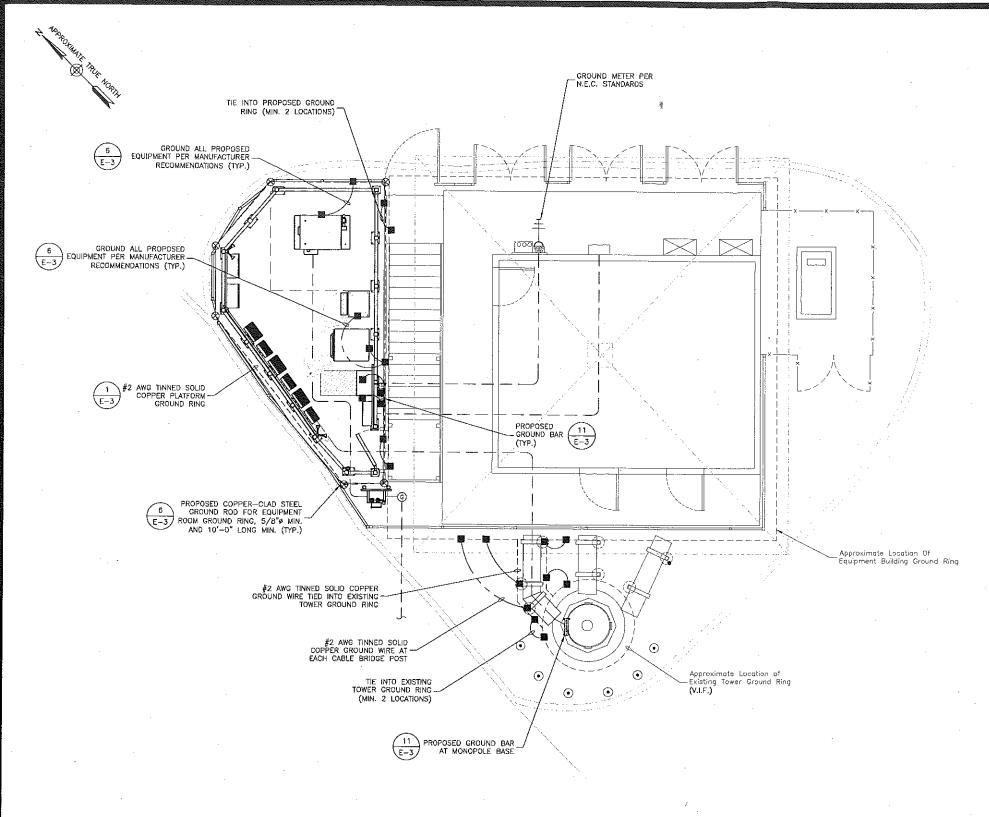
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IS A VIOLATION OF LAW FOR ANY PERSON, UNLES THEY ARE ACTING UNDER THE DIRECTION OF A LICENSED PROFESSIONAL ENGINEER TO ALTER THIS DOCUMENT.

1167 OCEAN AVE SEA BRIGHT, NJ 07760 MONMOUTH COUNTY

SHEET TITLE

ELECTRICAL RISER DIAGRAM & ELECTRICAL NOTES



GROUNDING PLAN SCALE: 1/8"=1" FOR 11"x17" 1/4"=1" FOR 22"x34"



GROUNDING GENERAL NOTES

1. ALL DOWN CONDUCTORS AND THE GROUND RING ALL DOWN CONDUCTORS AND THE GROUND RING CONDUCTOR SHALL BE #2 AWG, SOLID, BARE, TINNED COPPER, UNLESS OTHERWISE NOTED. ALL CONNECTIONS TO GROUND RING SHALL BE EXOTHERMICALLY WELDED. CONDUCTOR SHALL BE AT A MINIMUM DEPTH BELOW GRADE OF 18 INCHES OR TO LEDGE. MINIMUM BEND RADIUS SHALL BE 8 INCHES CONDUCTOR SHALL BE AT LEAST 24 INCHES FROM ANY FOUNDATION, UNLESS OTHERWISE NOTED.

- GROUND RODS SHALL BE 5/8" DIAMETER COPPER CLAD, HARGER, T&B, ERICO, OR EQUIVALENT. TOP OF ROD SHALL BE A MINIMUM OF 18" BELOW GRADE. IF LEDGE IS ENCOUNTERED, INSTALL GROUND ROD AT AN ANGLE, ELECTRICAL METER GROUND ROD EXCEPTED.
- WHERE MECHANICAL CONNECTIONS ARE SPECIFIED, BOLTED, COMPRESSION—TYPE, CLAMPS OR SPLIT—BOLT TYPE CONNECTORS SHALL BE USED.
- GRIND OFF GALVANIZING IN AFFECTED AREA. EXOTHERMICALLY WELD #2 CONDUCTOR AT 6' ABOVE GRADE OR FOUNDATION, WHICHEVER IS HIGHER.
 COLD—GALV AFTER. EXOTHERMICALLY WELD OTHER END
- 5. INSTALL GROUNDING KITS AT ANTENNA CENTERLINE, AND TOWER EXIT POINTS. GROUND COAX LINES. EXOTHERMICALLY WELD #2 DOWN CONDUCTOR TO PLATES, RUN DOWN TOWER, AND TIE INTO GROUNDING
- ALL GROUNDING WORK SHALL COMPLY WITH AT&T CONSTRUCTION CONTRACT STANDARDS. FOLLOWING COMPLETION OF WORK, GROUND SYSTEM MUST BE TESTED AND SHALL HAVE A RESISTANCE OF 5 OHMS OR LESS SUBMIT AN INDEPENDENT "FALL POTENTIAL" TESTING REPORT.
- 7. ALL GROUNDING CONDUCTORS ON EXTERIOR WALL OF SHELTER SHALL BE INSTALLED IN 3/4" SCH 40 PVC CONDUIT TO 12" BELOW GRADE. ATTACH PVC WITH GALVANIZED "C" CLAMPS.
- CONTRACTOR SHALL HAND—DIG IN AREAS AROUND EXISTING UTILITIES.
- NOTIFY CONSTRUCTION ENGINEER IF THERE ARE ANY DIFFICULTIES INSTALLING GROUNDING SYSTEM DUE TO SITE SOIL CONDITIONS.
- GROUNDING RING IS SHOWN AS SCHEMATIC ONLY. IT IS DESIGNED WITHOUT BENEFIT OF RESISTIVITY TESTING AND DOES NOT NECESSARILY REPRESENT A GROUNDING SYSTEM TO MEET ANY SPECIFIC GROUND
- 11. PRIOR TO POURING CONCRETE, ALL REBAR LOCATED NEAR THE BOTTOM OF THE FOUNDATION SHALL BE BONDED TOGETHER TO FORM A SINGLE GROUNDING ELECTRODE, BY STEEL TIES OF OTHER EFFECTIVE MEANS APPROVED BY NEC 2011 AND STRUCTURAL ENGINEER, AND BONDED TO THE GROUND RING AS DETAILED IN THESE PLANS. (INSPECTION MAY BE REQUIRED PRIOR TO POURING CONCRETE AND MUST BE COORDINATED BY CONTRACTOR.)
- 12. IN ACCORDANCE WITH NEC 2011 REQUIREMENTS, ALL GROUNDING ELECTRODES PRESENT ON SITE SHALL BE BONDED TOGETHER (REFERENCE 2011 NEC ARTICLE
- 13. CAULK AND SEAL ALL NON-FACTORY SHELTER PENETRATIONS.

- GROUND UTILITY METER PER N.E.C.
- CONTRACTOR TO VERIFY WITH C.M. FOR FINAL GROUND METHOD.

GROUNDING LEGEND

(100000)	GROUND BAR
	GROUND COPPER WIRE, SIZE AS NOTED
	MECHANICAL GROUND CONNECTION
8	5/8"X10' COPPER CLAD STEEL GROUND ROD
	EXOTHERMIC (CADWELD) CONNECTION



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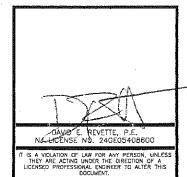


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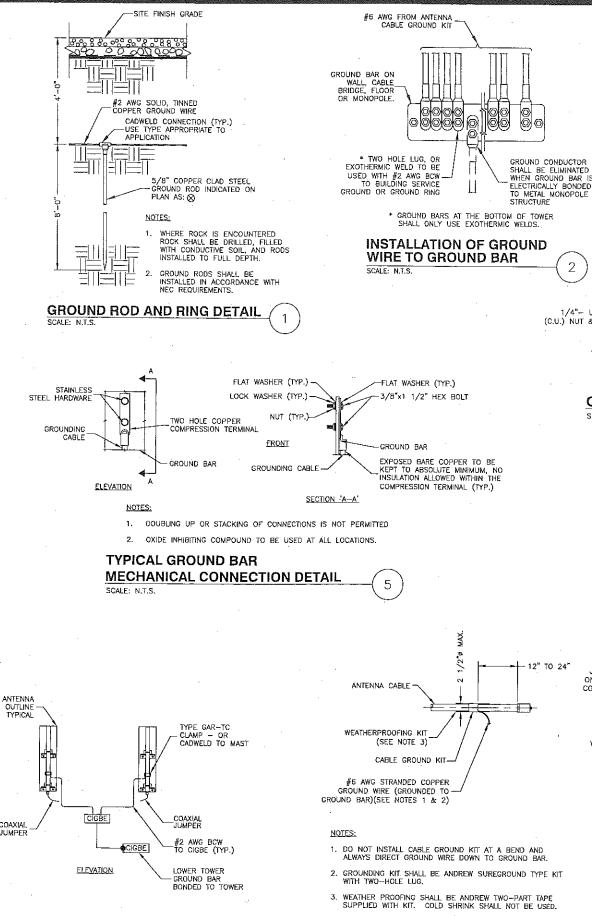
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SHEET TITLE

GROUNDING PLAN & GROUNDING NOTES

SHEET NUMBER

E-2



CONNECTION OF CABLE GROUND


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KIT TO ANTENNA CABLE DETAIL

ANTENNA MOUNT

SCALE: N.T.S.

GROUNDING DETAIL

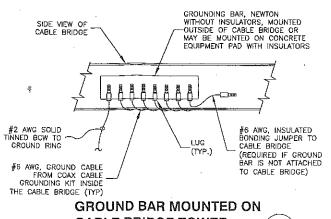


GROUND BAR MOUNTED ON CABLE BRIDGE TOWER
SCALE: N.T.S.


1/4"- UNC X 1/2" BOLT
U.) NUT & WASHERS (TYP.)

#2 INSULATED GREEN STRANDED TAP (C.U.)

CONNECTION TO EQUIPMENT DETAIL SCALE: N.T.S.

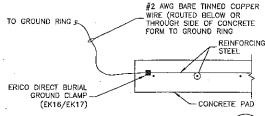


REBAR GROUNDING DETAIL

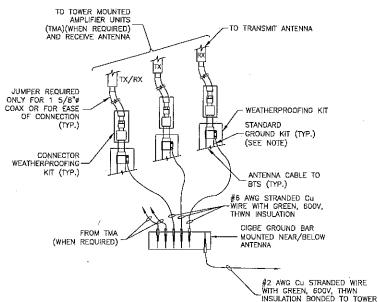

 DO NOT INSTALL CABLE GROUND KIT AT A BEND AND ALWAYS DIRECT GROUND WIRE DOWN TO CIGBE.

STEEL OR MONOPOLE

CONNECTION OF GROUND WIRE
TO GROUNDING BAR DETAIL
SCALE, NTS
10

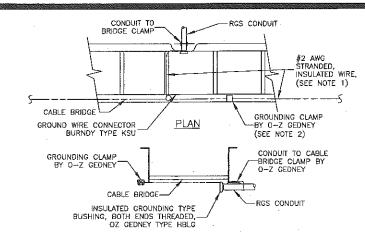

NOTES:

SECTION


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1. GROUND WIRE CONNECTED TO RING GROUND.

2. ATTACH GROUNDING CLAMP ON EACH SECTION OF CABLE BRIDGE, SPACING SHALL NOT EXCEED 12'-0".


CABLE BRIDGE GROUNDING AND RGS CONDUIT RUN DETAIL

RGS CONDUIT RUN DETAIL
SCALE: N.T.S.

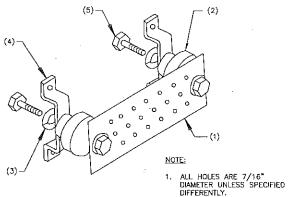

LEGEND:

- COPPER GROUND BAR, 1/4"x4"x20", GBIT 14420 J 2-7. HOLE CENTERS TO MATCH NEMA DOUBLE LUG CONFIGURATION.
- 2. STANDOFF INSULATORS, HARGER LIGHTNING PROTECTION, INC. CAT. No. 5263-A8.
- 3. 1/2" LOCKWASHERS, HARGER CO. CAT. No. LWBS.
- 4. WALL MOUNTING STAINLESS STEEL, MOUNTING BRACKET, HARGER CAT NO. WBKT-1.
- 5. $1/2-13 \times 1"$ HEX HEAD CAP SCREW, HARGER, CAT No. CS88S.

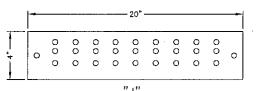

THE GROUND BAR IS 1/4" THICK, 4" WIDE, 20" LONG. IT HAS A HOLE PATTERN "J" WITH A NO. 2 AWG SOLID TINNED TAIL.



 $\underline{\text{STYLE}};$ GBIT - GROUND BAR WITH WALL MOUNTING BRACKETS, INSULATORS AND A 25' EXOTHERMICALLY WELDED TAIL.

 $\underline{\text{SIZE}};$ THICKNESS, WIDTH, LENGTH IN INCHES.

HOLE PATTERN: HOLE PATTERN CENTERS MATCH NEMA DOUBLE LUG CONFIGURATION, SEE ISOMETRIC.

TAIL: SPECIFY AMERICAN WIRE GAUGE (AWG) SIZE AND STRANDING REQUIRED. 25' LENGTH IS STANDARD UNLESS OTHERWISE' REQUESTED.

GROUND BAR DETAIL 11



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JOB NUMBER:	5011061
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SHEET TITLE

GROUNDING DETAILS

SHEET NUMBER

F-3

GENERAL PLUMBING NOTES

- 1. ALL UNDERGROUND PIPE SLEEVES SHALL BE COORDINATED WITH SITE ENGINEER FOR SIZE, LOCATION AND ELEVATION.
- 2. UNNECESSARY NOISE SHALL BE AVOIDED AT ALL TIMES AND NECESSARY NOISE SHALL BE REDUCED TO A MINIMUM.
- 3. WHERE THE WORK MAKES TEMPORARY SHUT DOWNS OF SERVICE UNAVOIDABLE, THEY SHALL BE MADE AT NIGHT OR AT TIMES AS THIS WILL CAUSE THE LEAST INTERFERENCE WITH THE ESTABLISHED OPERATING ROUTINE OF THE BUILDING.
- 4. CONTRACTOR SHALL CHECK AND VERIFY THE EXACT LOCATION OF ALL PIPE PENETRATIONS AND PIPE ELEVATIONS.
- 5. ALL INDICATED WORK SHALL BE PERFORMED BY THE PLUMBING CONTRACTOR UNLESS OTHERWISE NOTED.
- 6. IT IS THE RESPONSIBILITY OF THE PLUMBING CONTRACTOR TO REVIEW THESE PLANS AND SPECIFICATIONS, AS WELL AS THE RELATED HVAC, FIRE PROTECTION, ELECTRICAL, STRUCTURAL, ARCHITECTURAL, INTERIOR DECOR AND SITE ENGINEERING DRAWINGS TO BECOME FAMILIAR WITH THE FULL PROJECT SCOPE. IN ADDITION, THIS CONTRACTOR MUST COORDINATE WITH AN OWNER REPRESENTATIVE TO FULLY UNDERSTAND ALL REQUIREMENTS WHICH MAY NOT BE SPECIFIED HEREIN AND WHICH THE OWNER MAY CONSIDER PART OF THIS CONTRACT. DURING THE COURSE OF CONSTRUCTION COORDINATION AND ACTUAL CONSTRUCTION, IT IS THE RESPONSIBILITY OF THE PLUMBING CONTRACTOR TO WORK CLOSELY WITH ALL ACCOMPANYING CONTRACTORS AND TRADESMEN IN ORDER TO ENSURE A SMOOTH RUNNING AND CAREFULLY COORDINATED INSTALLATION.
- 7. ANY DISCREPANCIES OR INADEQUACIES WITHIN THESE BID DOCUMENTS OR BETWEEN THESE BID DOCUMENTS AND THE RELATED HVAC, FIRE PROTECTION, ELECTRICAL, STRUCTURAL, INTERIOR DECOR AND SITE ENGINEERING DRAWINGS, OR BETWEEN THESE BID DOCUMENTS AND FIELD CONDITIONS MUST BE BROUGHT TO THE ATTENTION OF THE OWNER, ARCHITECT AND ENGINEER PRIOR TO BID SUBMISSION.
- B. THE PLUMBING CONTRACTOR MUST VISIT THE SITE AND NOTE ALL EXISTING CONDITIONS AS WELL AS CONDITIONS TO BE MET PRIOR TO BID SUBMISSION. LACK OF A THOROUGH UNDERSTANDING OF THE PROJECT SCOPE AND CONDITIONS SHALL NOT CONSTITUTE AN EXCUSE FOR ERRORS OR OMISSIONS, NOR FOR A REQUEST FOR EXTRA COMPENSATION.
- 9. ALL REQUIRED OFFSETS, RISES AND DROPS DUE TO POSSIBLE OBSTRUCTIONS OF PIPE RUNS ARE NOT NECESSARILY SHOWN. PLUMBING CONTRACTOR SHALL INCLUDE A CONTINGENCY IN HIS BID TO OFFSET ANY COST REQUIRED FOR ADDITIONAL FITTINGS AND LABOR THAT MAY BE REQUIRED.
- 10. ALL UTILITY TIES WILL BE MADE ON PREMIUM TIME, COORDINATE ALL SHUT-DOWNS WITH OWNER.
- 11. MAKE SUBMITTALS OF SHOP DRAWINGS AS SPECIFIED.
- 12. WORK IS NOT SHOWN IN FINITE DETAIL BUT IS INTENDED TO INCLUDE ITEMS NECESSARY FOR COMPLETION AND PROPER OPERATION.
- 13. NO DEAD ENDS SHALL BE LEFT ON ANY PIPING UPON COMPLETION OF WORK.
- 14. ALL SYSTEMS SHALL BE LEFT IN PERFECT WORKING ORDER UPON COMPLETION OF ALL NEW WORK.
- 15. SUPPLY TWO COPIES OF A WARRANTY COUNTERSIGNED AND GUARANTEED BY CONTRACTOR, STATING THAT IMPERFECT SYSTEM OPERATION AND ALL DEFECTS IN LABOR AND MATERIALS OF PLUMBING WORK WILL BE REPAIRED WITHOUT COST TO OWNER FOR A PERIOD OF ONE YEAR FROM DATE OF SUBSTANTIAL COMPLETION, AND STATING THAT ALL PLUMBING EQUIPMENT HAS BEEN FULLY SERVICED AND LEFT IN PROPER OPERATING CONDITION.
- 16. GUARANTEE THAT SERVICING WILL BE PROVIDED WITHOUT COST DURING GUARANTEE PERIOD.
- 17. LOCATION OF ALL FULL-OPEN VALVES AND SHUTOFF VALVES SHALL BE INSTALLED PER THE NATIONAL STANDARD PLUMBING CODE, 2009, WHETHER SPECIFICALLY SHOWN ON DRAWINGS OR NOT.
- 18. ITEMS NEEDING SAWCUTTING AND PATCHING SHALL BE COORDINATED BETWEEN TRADES. ONLY MAJOR PIECES ARE SHOWN ON DRAWINGS AND DO NOT INDICATE ALL LOCATIONS. PLUMBER SHALL BE RESPONSIBLE FOR CONCEALING ALL NEW WORK, UNLESS NOTED OTHERWISE.
- ALL STEEL HANGERS, SUPPORTS, INSULATION SHIELDS, CLAMPS, STEEL ANGLES, BEAM HOOKS, THREADED RODS, CONCRETE INSERTS, NUTS, ROD COUPLINGS, CHANNELS, ETC... SHALL BE ELECTRO—GALVANIZED OR HOT—DIP GALVANIZED.

PLUMBING SYSTEM CONTROL WIRING NOTES

- THE PLUMBING CONTRACTOR SHALL PROVIDE ALL LABOR, MATERIALS AND SERVICES FOR LINE VOLTAGE AND LOW VOLTAGE CONTROL WIRING, INCLUDING ALL
 CONDUITS, WIRING, HARDWARE'S, SOFTWARE'S, RELAYS, CONTROL MODULES AND ALL ACCESSORIES AND SERVICES NECESSARY AND AS REQUIRED FOR A COMPLETE
 FUNCTIONAL INSTALLATION OF THE EMERGENCY GENERATOR INCLUDING GAS SHUTOFF SOLENDID VALVES CONTROL, AS PER DRAWINGS AND SPECIFICATIONS.
- 2. THE PLUMBING CONTRACTOR SHALL RETAIN AND PAY FOR A LICENSED ELECTRICAL CONTRACTOR TO INSTALL THE COMPLETE PLUMBING CONTROL WIRING SYSTEMS.

NATURAL GAS NOTES

- 1. INSTALL VALVES IN ALL SERVICE CONNECTIONS IN ALL BRANCH LINES.
- 2. CHANGES IN PIPE SIZES SHALL BE MADE WITH REDUCING OR INCREASING FITTINGS.
- 3. USE SEALANT ON METAL GAS PIPING THREADS WHICH ARE CHEMICALLY RESISTANT TO NATURAL GAS. USE SEALANT SPARINGLY, AND APPLY TO ONLY MALE THREADS OF METAL JOINTS.
- 4. REMOVE CUTTING AND THREADING BURRS BEFORE ASSEMBLING PIPING.
- 5. DO NOT INSTALL DEFECTIVE PIPING AND FITTINGS. DO NOT USE PIPE WITH THREADS WHICH ARE CHIPPED, STRIPPED AND DAMAGED.
- 6. PLUG EACH OUTLET INCLUDING VALVES WITH THREADS, PLUG OR CAP IMMEDIATELY AFTER INSTALLATION AND RETAIN UNTIL CONTINUING PIPING OR EQUIPMENT CONNECTION ARE COMPLETED.
- 7. INSTALL DRIP LEGS IN GAS PIPING WHERE REQUIRED BY CODE.
- 8. THE ENTIRE INSTALLATION SHALL BE GUARANTEED AND SERVICED FOR A PERIOD OF ONE YEAR FROM THE DATE OF FINAL ACCEPTANCE OF THE INSTALLATION BY THE OWNER.
- 9. THE CONTRACTOR SHALL DURING THE PERIOD OF THE GUARANTEE REPLACE OR REPAIR AT THEIR OWN EXPENSE ANY PIECE OF EQUIPMENT AND/OR MATERIAL WHICH IS FOUND TO BE DEFECTED. THE REPLACEMENT OR RE-PAIRMENT SHALL BE DONE AS SOON AS NOTIFIED.
- 10. ALL NEW EQUIPMENT SHALL BE HOOKED UP BY THIS CONTRACTOR. CONTRACTOR SHALL FURNISH AND INSTALL ALL REQUIRED VALVES, FITTINGS, ETC. NECESSARY FOR THE COMPLETE HOOK UP, AND TO PROVIDE PROPER OPERATION OF EACH PIECE OF EQUIPMENT.

FUEL GAS PRODUCTS NOTES

- 1. BOLTS, ANCHOR BOLTS AND NUTS -- ALL NECESSARY BOLTS, ANCHOR BOLTS, NUTS, WASHERS, PLATES AND BOLT SLEEVES SHALL BE PROVIDED IN ACCORDANCE HEREWITH. ANCHOR BOLTS SHALL HAVE SUITABLE WASHERS, LOCK WASHERS AND HEXAGONAL NUTS. BOLTS, ANCHOR BOLTS, NUTS AND WASHERS SPECIFIED TO BE GALVANIZED, SHALL BE ZINC COATED AFTER BEING THREADED BY THE HOT-DIP PROCESS.
- 2. PIPE HANGERS & SUPPORTS PIPE HANGERS AND SUPPORTS, HANGER RODS, PROTECTION SADDLES AND INSERTS SHALL BE TYPE NUMBERS BASED ON MANUFACTURER'S STANDARDIZATION SOCIETY SP-BB, UNLESS OTHERWISE INDICATED. PIPE COVERING PROTECTION SADDLES: TYPES 39 OR 40. PIPE HANGERS: TYPES 1, 41, AND 43, OR FEE AN MASON #212 SPLIT RING HANGERS WITH SUPPORTING RODS. SPRING HANGERS: TYPES 49, 51, OR 53. ANCHORS: GRINNELL FIG. 197 OR FEE & MASON FIG. 159. PIPE GUIDES: GRINNELL FIG. 256, C & P FIG. 1007, OR ELCEN FIG. 411.
- 3. ALL PIPING SYSTEMS SHALL BE SEISMIC ALLY BRACED IN ACCORDANCE WITH THE APPLICABLE SECTIONS OF THE INTERNATIONAL BUILDING CODE—NJ, 2009 AND NATIONAL FIRE PROTECTION ASSOCIATION (NFPA) CURRENT EDITION. REFER TO DETAILS FOR SEISMIC PIPE BRACING.
- 4. FUEL GAS PIPE INSIDE BUILDING: SIZES 3" AND SMALLER SHALL BE SCHEDULE 40 CARBON STEEL PIPE WITH MALLEABLE IRON SCREWED FITTINGS.
- 5. FUEL GAS PIPE OUTSIDE OF BUILDING SHALL BE PLASTIC HDPE UNDERGROUND PIPE AND FITTINGS WITH WELDED JOINTS. ALL HANGER MATERIALS OUTSIDE OF BUILDING TO BE HOT DIPPED CALVANIZED. ALL NUTS, WASHERS & BOLTS TO BE STAINLESS STEEL.
- 6. FUEL GAS SHUT-OFF VALVES 2-1/2" AND SMALLER: APOLLO 77.100 FULL PORT BRONZE BODY WITH TEE HANDLE. 2-1/2" AND LARGER: NORDSTORM 143, SERCK AUDCO LSW-133-GG, OR WALWORTH 175 PSI WORKING PRESSURE IRON BODY LUBRICATED PLUG VALVE WITH FLANGED ENDS.

INSTALLATION OF FUEL GAS PIPING SYSTEM NOTES

- ALL PIPING AND EQUIPMENT IS SHOWN DIAGRAMMATIC. EXACT LOCATIONS TO BE DETERMINED IN FIELD. INSTALL PIPING STRAIGHT, PLUMB AND AS DIRECT AS
 POSSIBLE. LOCATE GROUPS OF PIPES PARALLEL TO EACH OTHER; SPACE INDIVIDUAL PIPES IN ORDER TO PERMIT APPLICATION OF FULL INSULATION AND TO PERMIT
 ACCESS FOR SERVICING VALVES.
- ALL PIPING SHALL BE REAMED TO BE FREE OR BURRS. KEEP PIPING FREE FROM SCALE AND DIRT; PROTECT OPEN PIPE ENDS WHENEVER WORK IS SUSPENDED DURING CONSTRUCTION TO PREVENT FOREIGN MATERIAL ENTERING AND LODGING; USE TEMPORARY PLUG, PLASTIC, OR OTHER APPROVED MATERIAL FOR PROTECTION.
- 3. PIPING SHALL BE ACCURATELY CUT TO MEASUREMENTS ESTABLISHED IN THE FIELD AND INSTALLED IN PLACE WITHOUT COLD SPRINGING OR FORCING INTO ALIGNMENT. FLAME CUTTING OF BEVEL FOR WELDED JOINTS IS NOT ALLOWED, JOINTS SHALL BE FREE OF BURRS AND ALL WELD SPLATTER AND BEAOS REMOVED FROM JOINTS. JOINTS SHALL EXHIBIT FULL PENETRATION OF ROOT PASS AND FINAL PASS SHALL BE FREE OF UNDER CUTTING.
- 4. INSTALLATION AND TESTING SHALL COMPLY WITH NFPA 54 AND THE REQUIREMENTS OF THE APPROVING AUTHORITIES AND THIS SECTION. INSTALL PIPING PITCHED NOT LESS THAN 1/4" IN 15' SLOPE UPWARD TO RISERS AND DOWN TO METER AND EQUIPMENT. INSTALL BRANCH TEES OF THE SIDE OR TOP OF MAINS AND PROVIDE 6" MINIMUM SIZE DRIP LEGS AT LOW POINTS.
- 5. PROVIDE SHUT-OFF VALVE FLEXIBLE CONNECTOR AND UNION OR FLANGE AT EACH EQUIPMENT CONNECTION. LOCATE VALVE WITHIN 6' OF EQUIPMENT SERVED WITH UNION DOWNSTREAM OF VALVE. PROVIDE CONTROL VALVES AND SHUT-OFF VALVES IN ACCESSIBLE LOCATIONS. DRIP LEG TRAPS SHALL BE READILY ACCESSIBLE. IDENTIFY EACH VALVE WITH UNIQUE TAG NUMBER, VALVES INSTALLED GREATER THAN 7'-O" AFF/AFR SHALL BE CHAIN OPERATED.
- 6. INSTALL SYSTEM COMPONENTS AS REQUIRED FOR PROPER TESTING AS SPECIFIED IN THIS SECTION. PROVIDE AUXILIARY ISOLATION AND PURGE VALVES AS REQUIRED FOR CONSTRUCTION PHASING AND SYSTEM TESTING. REMOVE VALVE HANDLES FROM ALL AUXILIARY CONSTRUCTION PHASING AND TESTING VALVES AS DIRECTED BY THE OWNER.
- 7. CONNECTIONS TO EXISTING GAS SYSTEM:

ISOLATE THE EXISTING SECTION OF PIPING BY CLOSING THE CLOSEST UPSTREAM SHUT-OFF VALVE. TEST THE VALVE BY REDUCING THE DOWNSTREAM PRESSURE TO ATMOSPHERIC PRESSURE AND CLOSING ALL OUTLETS. MONITOR THE SYSTEM PRESSURE FOR AT LEAST 2 HOURS TO DETECT ANY INCREASE IN PRESSURE BY LEAKAGE THROUGH THE VALVE.

BEFORE TESTING THE ZONE VALVE, VERIFY THAT OUTLETS ARE NOT LEAKING BY PRESSURIZING THE SECTION OF PIPING BETWEEN THE ZONE VALVE BOX AND THE OUTLETS AND CLOSING THE ZONE VALVE BOX. THE SYSTEM SHOULD MAINTAIN THE SAME SYSTEM PRESSURE WITHOUT A PRESSURE DROP FOR AT LEAST 5 MINUTES.

WHILE WELDING THE NEW CONNECTION, PURGE THE PIPING WITH NITROGEN BACK THROUGH THE NEW CONNECTION FROM THE CLOSEST GAS OUTLET DOWNSTREAM OF THE NEW POINT OF CONNECTION.

PRESSURIZE THE SYSTEM WITH NITROGEN TO 45 PSIG AFTER WELDING IS COMPLETED. BLOW THE EXISTING PIPING CLEAR FROM THE CLOSEST DOWNSTREAM GAS OUTLET OUT THE NEW CONNECTION INTO A CLEAN WHITE CLOTH UNTIL THERE ARE NO SIGNS OF DISCOLORATION OR PARTICULATES.

REPRESSURIZE THE SYSTEM WITH NATURAL GAS AND PURGE ALL OUTLETS IN THE SYSTEM STARTING WITH THE OUTLET CLOSEST TO THE SOURCE OF SUPPLY, REPEATEDLY PURGE THE EXISTING SYSTEM THROUGH THE EXISTING OUTLETS INTO A CLEAN WHITE CLOTH AT NORMAL SYSTEM WORKING PRESSURE TO VERIFY THAT NO PARTICULATES REMAIN IN THE SYSTEM.

DO NOT MAKE THE NEW CONNECTION TO THE NEW ROUGHED-IN PIPING SYSTEM UNTIL AFTER THE 200 PSI PARTICULATE BLOW-DOWN HAS BEEN PERFORMED.

TEST THE NEW CONNECTION JOINT WITH SOAPY WATER AT NORMAL SYSTEM WORKING PRESSURE.

- 8. IDENTIFICATION OF PIPE DURING CONSTRUCTION: PROVIDE A 6"LONG COLOR—CODED SPRAY PAINT INDICATION ON THE BOTTOM OF PIPE SECTIONS DURING INSTALLATION. IDENTIFY EACH SECTION OF PIPE IMMEDIATELY AFTER INSTALLATION, DO NOT PAINT PIPE JOINTS.
- 9. FINAL IDENTIFICATION OF PIPING AND EQUIPMENT: FLOW ARROWS SHALL POINT FROM THE SOURCE TO THE OUTLETS. INSTALL MARKERS ON PAINTED PIPING ONLY AFTER PAINTING IS COMPLETE AND HAS BEEN ACCEPTED BY THE OWNER. INSTALL MARKER ADJACENT TO ACCESS PANELS IF PIPING IS CONCEALED. STENCIL EQUIPMENT SUCH AS THE EMERGENCY GENERATOR WITH THE NAME OF THE EQUIPMENT AND EQUIPMENT NUMBER. STENCILS SHALL BE AT LEAST 6" HIGH AND SHALL BE A CONTRASTING COLOR WITH THE EQUIPMENT FINISH.

FUEL GAS PIPING GENERAL NOTES

- REFERENCE STANDARDS ALL MATERIALS, EQUIPMENT WORK AND INSTALLATIONS SHALL BE IN ACCORDANCE WITH THE INTERNATIONAL FUEL GAS CODES 2015, AND THE APPLICABLE REQUIREMENTS OF THE NATIONAL FIRE PROTECTION ASSOCIATION (NFPA), AMERICAN NATIONAL STANDARDS INSTITUTE (ANSI), AMERICAN SOCIETY OF TESTING MATERIALS (ASTM), AMERICAN MEDICING MECHANICAL ENGINEERS (ASME), NATIONAL ELECTRIC MANUFACTURERS' ASSOCIATION (NEWA), AMERICAN WELDING SOCIETY (AWS), AND CAST IRON SOIL PIPE INSTITUTE(CISPI), AND ANY PERTINENT FEDERAL, STATE LOCAL CODES, LAWS AND ORDINANCES, WHICH REQUIREMENTS HAVE PRECEDENCE OVER THE SPECIFICATIONS IN THE EVENT OF ANY CONFLICT. ANY CONFLICT BETWEEN THE REQUIREMENTS OF THE ABOVE TIEMS OR WITH THESE SPECIFICATIONS SHALL BE REFERRED TO THE ENGINEER.
- 2. PERMITS, FEES, AND NOTICES SECURE AND PAY FOR THE BUILDING PERMITS AND FOR ALL OTHER PERMITS OR GOVERNMENTAL FEES, LICENSES, INSPECTIONS, AND NOTICES NECESSARY FOR THE EXECUTION AND COMPLETION OF THE WORK, WHICH ARE CUSTOMARILY SECURED AFTER EXECUTION OF THE CONTRACT, WHICH ARE LEGALLY REQUIRED AT THE TIME THE BIOS ARE RECEVED. GIVE ALL NOTICES AND COMPLY WITH ALL LAWS, ORDINANCES, RULES, REGULATIONS AND LAWFUL ORDERS OF ANY PUBLIC AUTHORITY BEARING ON THE PERFORMANCE OF THE WORK, GIVE SUFFICIENT NOTICE OF ITS READINESS FOR INSPECTION.
- 3. PROJECT RECORD DOCUMENTS MAINTAIN A SET OF DRAWINGS AT THE SITE ON WHICH SHALL BE ACCURATELY SHOWN THE ACTUAL INSTALLATION OF ALL WORK INDICATING THEREON ANY VARIATIONS FROM THE CONTRACT DRAWINGS, INCLUDING CHANGES IN SIZES, LOCATION AND DIMENSIONS. PROVIDE A COMPLETE SET OF AS-BUILT DRAWINGS TO OWNER AND ENGINEER UPON COMPLETION OF PROJECT.
- 4. OPERATING AND MAINTENANCE INSTRUCTIONS PROVIDE A COMPETENT ENGINEER OR TECHNICIAN TO INSTRUCT THE OPERATING PERSONNEL IN THE OPERATION AND MAINTENANCE OF EQUIPMENT AND SYSTEMS. A COPY OF THE OPERATING AND MAINTENANCE MANUAL SHALL BE PROVIDED AT THIS TIME. PROVIDE A MINIMUM OF 40 HOURS TRAINING ON MECHANICAL SYSTEMS, OR AS SPECIFIED IN EACH MECHANICAL SECTION OF THESE SPECIFICATIONS.
- 5. CLEANING KEEP THE WORK AREAS, INCLUDING ANY FABRICATION, AND STORAGE AREAS, FREE FROM ACCUMULATION OF WASTE MATERIALS OR RUBBISH CAUSED BY THIS OPERATION. AT THE COMPLETION OF THE WORK REMOVE ALL CONSTRUCTION DEBRIS, TEMPORARY FACILITIES AND EQUIPMENT FROM THE WORK AREA, AS WELL AS ALL TOOLS, CONSTRUCTION EQUIPMENT, MACHINERY, AND SURPLUS MATERIALS. IF THE CONTRACTOR FAILS TO CLEAN UP AT THE COMPLETION OF THE WORK, THE OWNER MAY DO SO AND THE COST THEREOF SHALL BE CHARGED TO THE CONTRACTOR.
- CUTTING AND PATCHING PERFORM ALL CUTTING, FITTING OR PATCHING REQUIRED TO COMPLETE THE WORK OR MAKE ITS SEVERAL PARTS FIT TOGETHER PROPERLY.
- 7. ELECTRICAL WORK MOTORS, COMBINATION MAGNETIC MOTOR STARTERS, SWITCHES AND CONTROLS SHALL BE FURNISHED FOR ALL ELECTRICALLY DRIVEN EQUIPMENT SPECIFIED HEREIN AND SHALL BE IN ACCORDANCE WITH THE PROVISIONS OF THE ELECTRICAL SPECIFICATIONS, ELECTRICAL POWER WIRING SHALL BE FURNISHED AND INSTALLED AS INDICATED ON THE ELECTRICAL DRAWINGS.
- PRIOR TO BEGINNING WORK, CONTRACTOR SHALL BE RESPONSIBLE FOR THE COORDINATION AND PROPER, RELATIONSHIP OF HIS WORK TO THE PROPERTY AND OTHER TRADES. ALL CONFLICTS SHALL BE RESOLVED BY THE GENERAL CONTRACTOR AND APPROVED BY THE ENGINEER. ALL WORK SHALL BE COORDINATED WITH ALL TRADES INVOLVES. OFFSETS FOR PIPING TO ACCOMMODATE OBSTRUCTIONS AND TRANSITIONS AROUND OBSTRUCTION SHALL BE PROVIDED WITH NO ADDITIONAL COST TO .



New Cingular Wireless PCS, LLC One AT&T Way Bedminster, NJ 07921



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DRAWN BY:	FG
REVIEWED BY:	BSH
CHECKED BY:	DER
PROJECT NUMBER:	50110598

1167 OCEAN AVE SEA BRIGHT, NJ 07760 MONMOUTH COUNTY

50110611

SHEET TITLE

JOB NUMBER

SITE ADDRESS:

GENERAL PLUMBING NOTES


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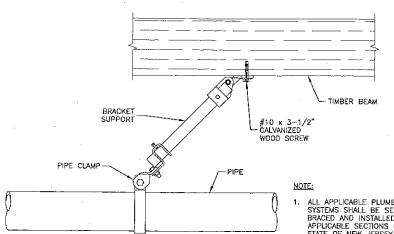
P-1



- THIS IS A SCHEMATIC REPRESENTATION. A GAS CONSULT MUST BE PERFORMED PRIOR TO START OF WORK FOR FINAL
- PROVIDE A COMPLETE GAS TRAIN SYSTEM WITH PIPING, REGULATORS, PRV, FILING, TESTING IN COMPLIANCE WITH NFPA, UTILITY Co. AND ALL AGENCIES, HAVING JURISDICTION.
- MARK EMERGENCY GENERATOR SHUTOFF VALVE AND BUILDING MAIN SHUTOFF VALVE IN ACCORDANCE WITH NEPA-110.
- MAINTAIN 12" SPACING BETWEEN GAS & ELECTRIC CONDUIT AT ALL TIMES.


GAS RISER DIAGRAM



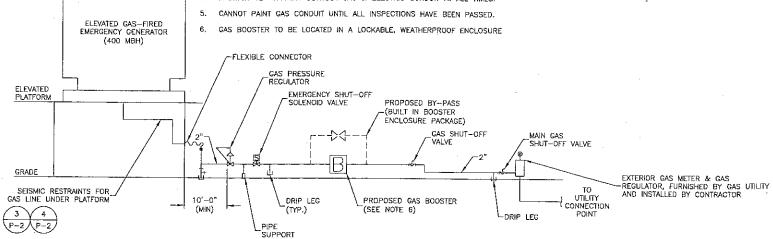


ALL APPLICABLE PLUMBING PIPING SYSTEMS SHALL BE SEISMICALLY BRACED AND INSTALLED PER APPLICABLE SECTIONS OF THE STATE OF NEW JERSEY BUILDING CODE LATEST EDITIONS.


LONGITUDINAL BRACE SEISMIC PIPE BRACING DETAIL SCALE: N.T.S.

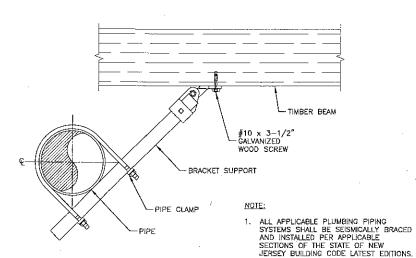

LATERAL (TRANSVERSE) **BRACE DETAIL** SCALE: N.T.S.

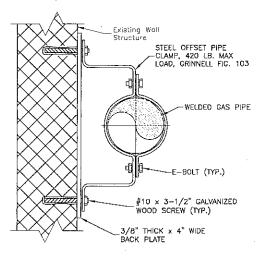

PIPE SUPPORT DETAIL

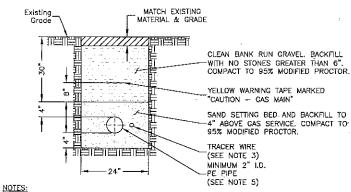

- 1. ALL EXCAVATION SHALL BE HAND EXCAVATION ONLY.
- 2. PE PIPE INSTALLATION SHALL BE IN ACCORDANCE WITH UTILITY COMPANY
- 3. A YELLOW INSULATED COPPER TRACER WIRE SHALL BE INSTALLED ADJACENT TO UNDERGROUND NONMETALLIC PIPING, ACCESS SHALL BE PROVIDED TO THE TRACER WIRE OR THE TRACER, WIRE SHALL TERMINATE ABOVE GROUND AT EACH END OF THE NONMETALLIC PIPING. THE TRACER WIRE SIZE SHALL NOT BE LESS THAN 18 AWG AND THE INSULATION TYPE SHALL BE SUITABLE FOR DIRECT BURIAL, COMPLIANT TO IFGC SECTION 404.15.3.
- 4. SPLICE BETWEEN STEEL GAS PIPE & PE PIPE TO BE THREADED.
- 5. THIS IS A SCHEMATIC TRENCH DETAIL. A GAS CONSULT MUST BE PERFORMED PRIOR TO START OF WORK FOR FINAL SIZING OF NATURAL GAS PIPE

GAS TRENCH	DETAIL	
SCALE: N.T.S.		(O



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DRAWN BY: FG REVIEWED BY: BSH DER CHECKED BY:

PROJECT NUMBER: 50110598

50110611 JOB NUMBER:

SITE ADDRESS:


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SHEET TITLE


GAS RISER DIAGRAM & PLUMBING DETAILS

SHEET NUMBER

P-2

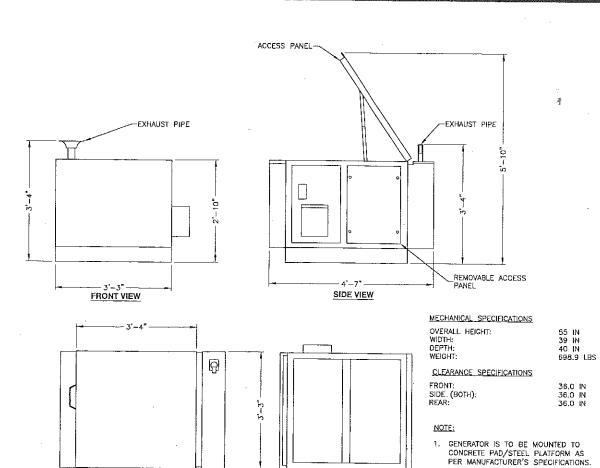

PLAN VIEW

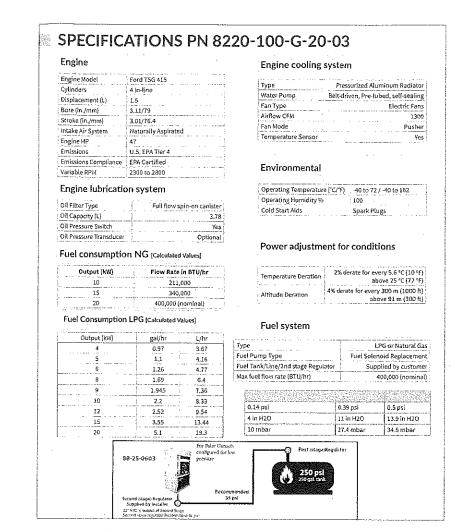

20kW NATURAL GAS GENERATOR DETAIL


SCALE: N.T.S

BOTTOM VIEW (BASE)

Korfund "CE" vibration isolators

	Quantity Max load included per per isolat		Dimensions (in)						Spring	Static	
Part number	Part number	per isolator (lbs)	Α	В	С	D	Е	F	G	constant lbs/in	deflection (in)
0402-0690-11	4	600	3	7-1/2	6-1/2	4-1/2	5-1/4	5/8	1/2	513	1.17
0402-0690-12	4	750	3	7-1/2	6-1/2	4-1/2	5-1/4	5/8	1/2	707	1.06
0402-0690-13	4	900	3	7-1/2	6-1/2	4-1/2	5-1/4	5/8	1/2	881	1.02
0402-0690-14	4	1100	3	7-1/2	6-1/2	4-1/2	5-1/4	5/8	1/2	1327	0.83
0402-0690-15	4	1300	3	7-1/2	6-1/2	4-1/2	5-1/4	5/8	1/2	1758	0.74
0402-0691-02	2	2200	3	10-1/4	9-1/4	7-1/2	5-5/8	5/8	5/8	2654	0.83
0402-0691-04	2	2600	3	10-1/4	9~1/4	7-1/2	5-5/8	5/8	5/8	3516	0.74

Note: "CE" isolators cannot to be used with sub-base fuel tanks (159-1486-xx, 159-1512-xx, or 179-4921-xx).

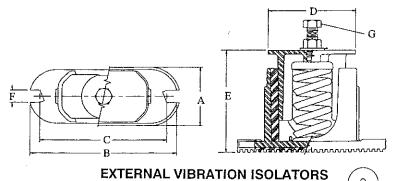



- CONTRACTOR TO INSTALL (4)
 VIBRATION ISOLATORS PER
 MANUFACTURER RECOMMENDATIONS.
- . VIBRATION ISOLATOR TO BE ANCHORED TO PROPOSED STEEL PLATFORM FRAMING WITH (2) 3/4"ø ASTM A325 STRUCTURAL BOLTS.
- CONFIRM VIBRATION ISOLATER WITH GENERATOR MANUFACTURER PRIOR TO INSTALLATION.



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C	CONST	RUCTION DRAWINGS
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IT IS A VIOLATION OF LAW FOR ANY PERSON, UNLE THEY ARE ACTING UNDER THE DIRECTION OF A LICENSED PROFESSIONAL ENGINEER TO ALTER THI OCCUMENT.

DRAWN BY:

REVIEWED BY: BSH

CHECKED BY: DER

FG

PROJECT NUMBER: 50110598

JOB NUMBER: 50110611

SITÉ ADDRESS:

1167 OCEAN AVE SEA BRIGHT, NJ 07760 MONMOUTH COUNTY

SHEET TITLE

NATURAL GAS GENERATOR DETAILS

SHEET NUMBER

P-3

FUEL GAS PRODUCTS:

1. GAS PRESSURE BOOSTER

FURNISH AND INSTALL AN ETTER COMPANY, MODEL FL 101—P, HERMETIC TYPE GAS PRESSURE BOOSTER PACKAGE COMPLETE WITH OUTDOOR ENCLOSURE.


- CAPACITY AND CONDITIONS OF SERVICE:
- 800 CFH OF NATURAL GAS; 0.65 SP. GR. 4.0" W.C. INLET PRESSURE.
- 12.0" W.C. OUTLET PRESSURE
- 1/4 HP EXPLOSION-PROOF MOTOR; CLASS 1, GROUP D. FOR OPERATION WITH 120V/1 PH/60 HZ POWER.
- U.L. LISTED.
- B. THE SYSTEM SHALL INCLUDE THE FOLLOWING:
- UL LISTED MAGNETICALLY COUPLED GAS BOOSTER, EG&G ROTRON.
- SUPPLY PRESSURE GAGE WITH PETCOCK.
 INLET SHUT-OFF VALVE, ECLIPSE.

- (11) DISCHARGE PRESSURE GAGE WITH PETCOCK.
 (12) VENTLESS RECYCLING HIGH/LOW PRESSURE SWITCH FOR OPERATIONAL DEADBAND
- (13) LOCK UP DISCHARGE REGULATOR.
- (14) LOCKABLE ENCLOSURE.
 (15) GENERATOR UPS POWER BACK-UP, MINIMUM RUN TIME SEVEN MINUTES AT 100% CHARGE.
- C. PRESSURE BOOSTER SHALL BE FURNISHED WITH A FACTORY—INSTALLED EXPLOSION—PROOF JUNCTION BOX FOR ELECTRICAL POWER CONNECTION.
- PRESSURE BOOSTER SHALL BE FURNISHED WITH AN INTEGRATED CONTROL SYSTEM CONSISTING OF MOTOR STARTER; FUSED DISCONNECT/INTERLOCK SWITCH; BOOSTER MANUAL—OFF—AUTO SWITCH; LOW GAS PRESSURE SWITCH; HICH GAS PRESSURE SWITCH; ALARM HORN; RELAYS; CONTROL CIRCUIT TRANSFORMER; SIGNAL LIGHTS FOR POWER, BOOSTER ON, LOW GAS PRESSURE, AND HIGH GAS PRESSURE. SYSTEM COMPONENTS, AS APPLICABLE, SHALL BE MOUNTED AND PREVIEWED IN A NEW ALE AND AND CONTROL OF MOUNTED AND PREVIEWED IN A NEW ALE AND AND CONTROL OF MOUNTED AND PREVIEWED IN A NEW ALE AND AND CONTROL OF MOUNTED AND PREVIEWED IN A NEW ALE AND AND CONTROL OF MOUNTED AND PREVIEWED IN A NEW ALE AND AND CONTROL OF MOUNTED AND PREVIEWED IN A NEW ALE ALL AND AND CONTROL OF MOUNTED AND PREVIEWED IN A NEW ALE ALL AND AND CONTROL OF MOUNTED AND PREVIEWED IN A NEW ALE ALL AND AND CONTROL OF MOUNTED AND PREVIEWED AND A NEW ALE ALL AND AND CONTROL OF MOUNTED AND PREVIEWED AND A NEW ALE ALL AND AND CONTROL OF MOUNTED AND PREVIEWED AND A NEW ALE ALL AND CONTROL OF MOUNTED AND PREVIEWED AND A NEW ALE ALL AND CONTROL OF MOUNTED AND A NEW ALE ALL AND CONTROL OF MOUNTED AND ADDRESSED AND AND CONTROL OF MOUNTED AND ADDRESSED AND AND CONTROL OF MOUNTED AND ADDRESSED AND CONTROL OF MOUNTED AND ADDRESSED AND CONTROL OF MOUNTED AND CONTROL OF MOUNTED AND ADDRESSED AND CONTROL OF MOUNTED AND CONT SHALL BE MOUNTED AND PREWIRED IN A NEMA 12 PANEL WITH NUMBERED TERMINAL STRIPS FOR CONNECTION OF EXTERNAL
- PRESSURE BOOSTER SHALL BE ELECTRICALLY INTERLOCKED WITH STANDBY GENERATOR TO OPERATE ON DEMAND ONLY WHEN THE GENERATOR IS OPERATING.

PROPOSED 1" DIA. PIPE SUPPLY GAS INLET EMERGENCY 4 POWER GENERATOR 4 FACILITY EMERGENCY 4 TON. 20 FIELD WIRING 3	
ITEM # QTY. DESCRIPTION 1 1 CONTROL PANEL 2 1 INLET PRESS. SWITCH 3 3 PRESSURE CAUGE 4 2 FLEXIBLE JOINTS 5 1 GAS BOOSTER 6 3 BALL VALVE 7 1 SWITCH SHUTOFF VALVE 8 1 3" TO 1" REDUCER 9 2 ISOLATION VALVE 10 2 CHECK VALVE 11 1 PRESSURE REGULATOR 12 1 BY-PASS VALVE	NOTES: 1. ALTHOUGH THE PRESSURE REGULATOR (ITEM 11) IS SHOWN IN A VERTICAL POSITION, IT SHOULD BE INSTALLED IN AN UPRIGHT / HORIZONTAL POSITION FOR PROPER OPERATION. 2. UTILITY CONSULT IS REQUIRED PRIOR TO FINALIZING GAS DESIGN AND REQUIREMENTS.

GAS BOOSTER				
MAKE:	AETECH ENGINEERED SYSTEMS			
MODEL:	GENPAC MODEL MD101-ATT			



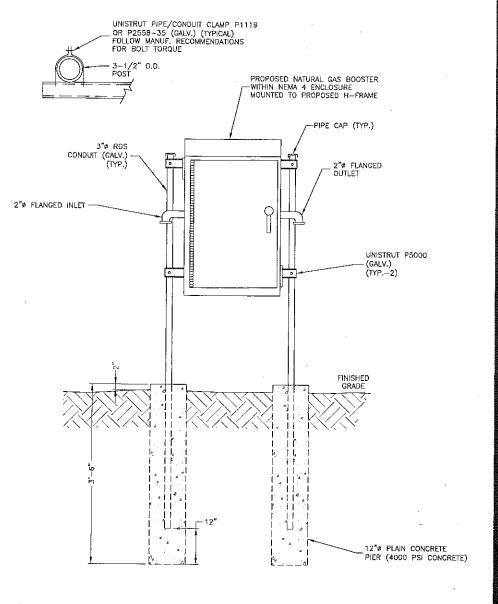

NOTE:

1. MOUNT METER BANK AND MAIN LUGS SECTION PER MANUFACTURER'S RECOMMENDATION AND INSTRUCTIONS.

GAS BOOSTER MOUNTING DETAIL SCALE: N.T.S.



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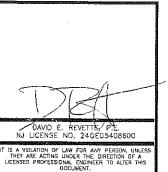
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SHEET TITLE

NATURAL GAS BOOSTER DETAILS